


# CAUTION: IT IS A VIOLATION OF THE NYS EDUCATION LAW ARTICLE 145, SECTION 7209 FOR ANY PERSON TO ALTER THIS ITEM IN ANY WAY, UNLESS HE OR SHE IS ACTING UNDER THE DIRECTION OF A LICENSED PROFESSIONAL ENGINEER.

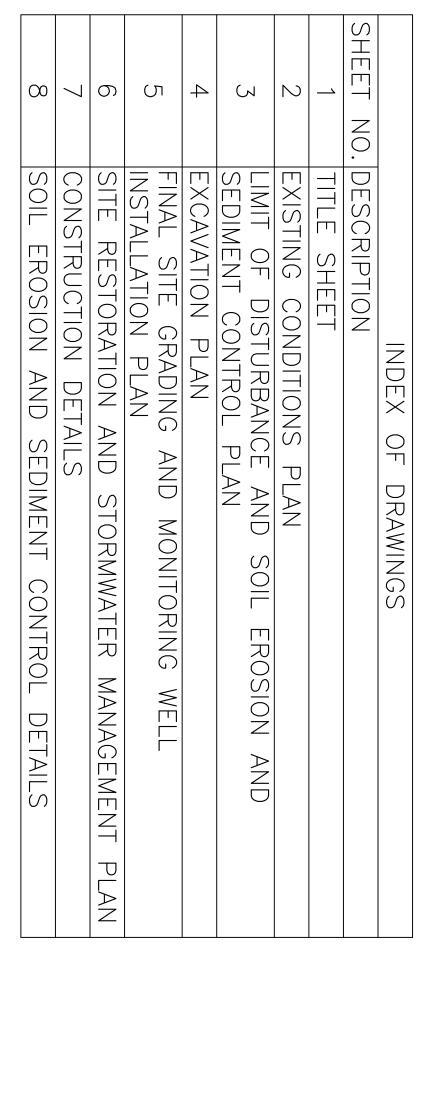

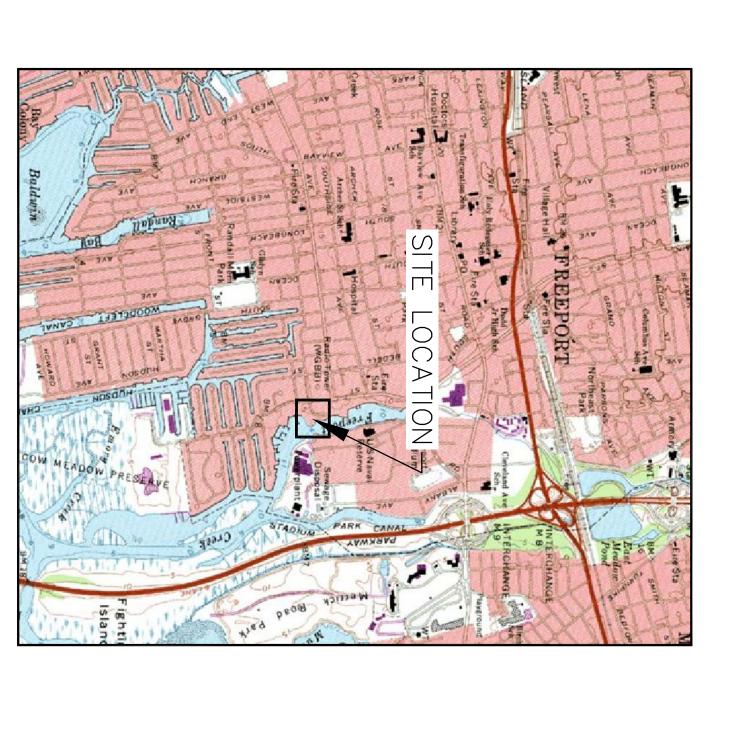

SITE

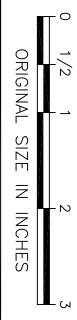

NEW YORK STATE DEPARTMENT OF ENVIRONMENTAL

CONSERVATION EA ENGINEERING, P.C. AND ITS AFFILIATE EA SCIENCE AND TECHNOLOGY

METAL ETCHING SITE REMEDIATION PROJECT
SITE, FREEPORT, NASSAU COUNTY, NEW YORK

## TITLE SHEET


12 MOUNT KEMBLE AVENUE		CHECKED BY: A.R.
ORRISTOWN, NEW JERSEY		APPROVED BY: A.K.
DATE:	PROJECT NO.:	SHEET NO.:
	5000	· )

SHEET NO.: 1 OF 8	PROJECT NO.: JG 50001	DATE:	SCALE:	SC/ AS
APPROVED BY: A.K.		MORRISTOWN, NEW JERSEY	MORRISTOW	
CHECKED BY: A.R.	; ; ;	412 MOUNT KEMBLE AVENUE	412 MOUNI	
DRAWN BY: A.L.		THE LOUIS BERGER GROUP INC	THE I OI	

A.R.

.> .×

YORK

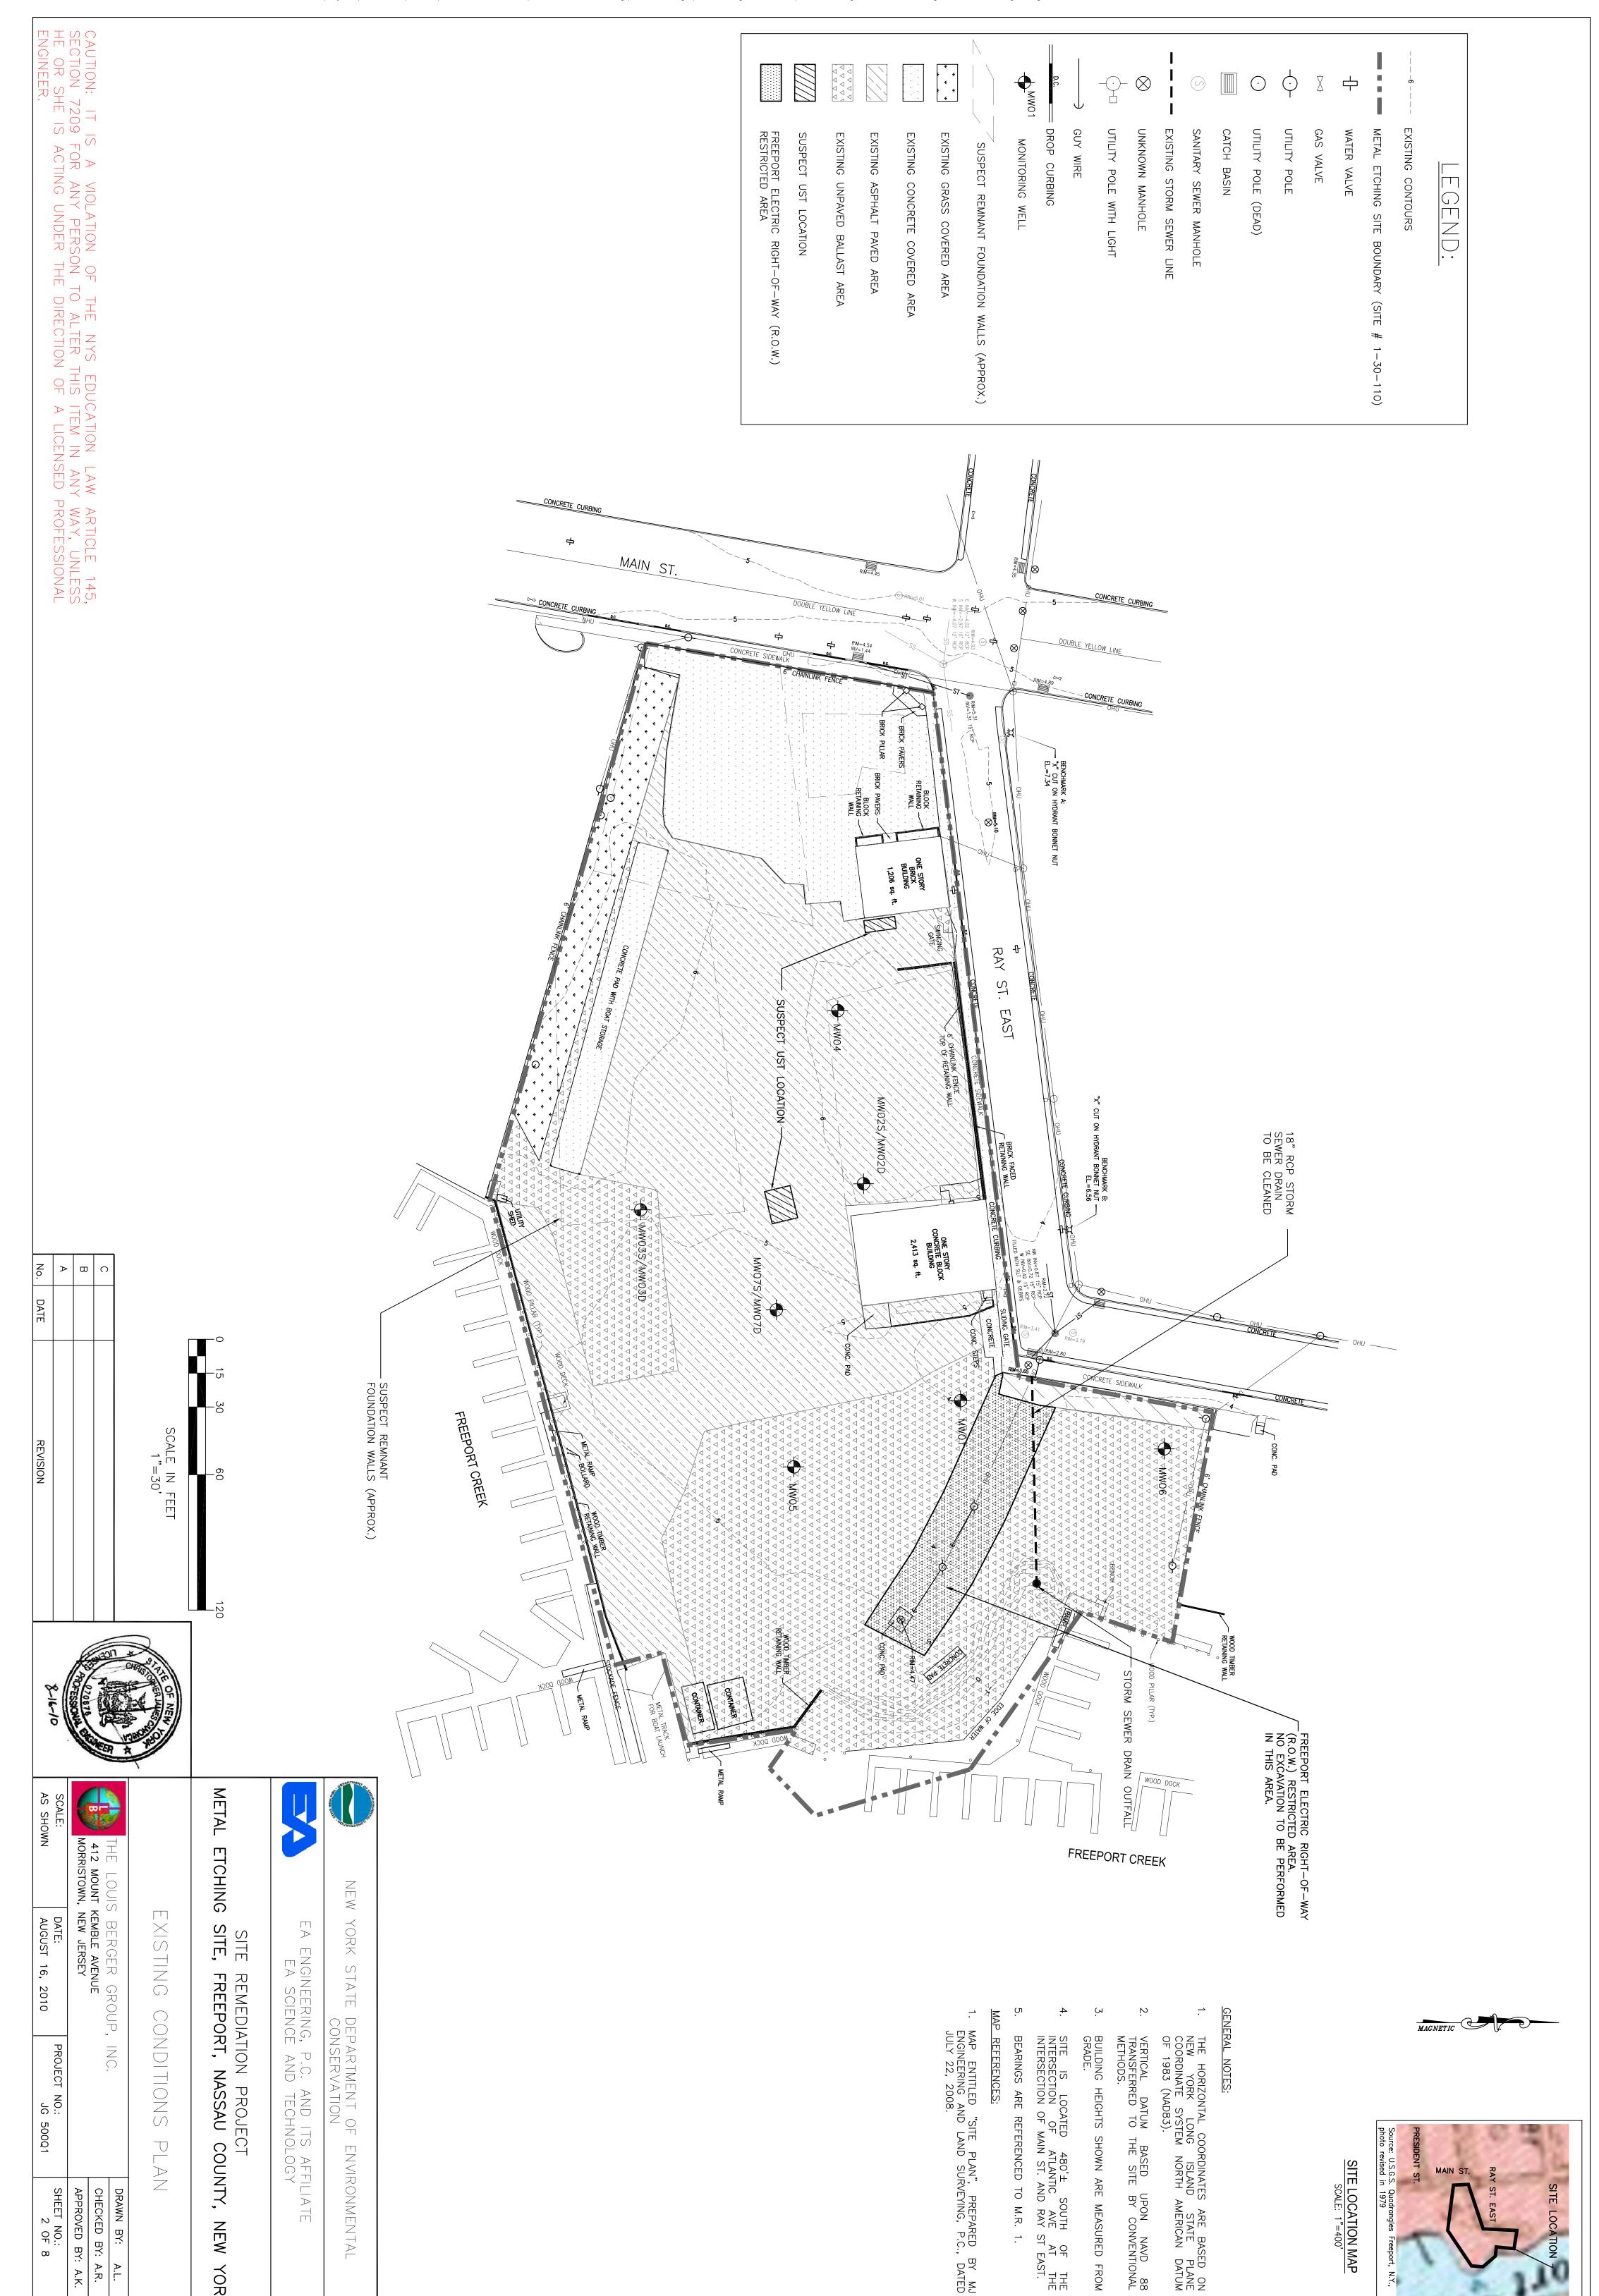

CONCRETE CURBING

MAP REFERENCES:

MAP ENTITLED "SITE PLAN", PREPARED ENGINEERING AND LAND SURVEYING, P.C., JULY 22, 2008.

BY MJ , DATED



THE LOUIS BERGER GROUP, 412 MOUNT KEMBLE AVENUE MORRISTOWN, NEW JERSEY  $\bigcirc$ DISTURBANCE SEDIMENT CO CONTROL Z () PLAZ EROSION CHECKED BY: DRAWN A.R.

PROJECT NO.:

APPROVED BY: A.K

METAL

**ETCHING** 

SITE,

SITE

REMEDIATION PROJECT FREEPORT, NASSAU CO

COUNTY,

NEW

YORK

SCALE IN FEET 1"=30'

 $\mathbb{Z} = \mathbb{X}$ ENGINEERING, EA SCIENCE DEPARTMENT CONSERVATION P.C. AND AND ITS AFFILIATE TECHNOLOGY

YORK SEDIMENTS IN 18" RCP STORM SEWER LINE ALONG THE NORTHEASTERN PORTION OF THE SITE SHALL BE CLEANED OUT AND REMOVED IN ACCORDANCE WITH SPECIFICATION SECTION 02113 — REMOVAL AND HANDLING OF SEDIMENT FROM STORMWATER SYSTEM. STATE  $\bigcirc \vdash$ ENVIRONMENTAL

15. <u>1</u>4. IF UNDERGROUND STORAGE TANKS (USTs) ARE ENCOUNTERED AT SUSPECT LOCATIONS SHOWN ON THIS PLAN OR AT ANY OTHER DISTURBED LOCATIONS, CONTRACTOR SHALL DECOMMISSION, CLOSE, AND REMOVE USTs AS PER SPECIFICATION SECTION 02114 — UNDERGROUND STORAGE TANK REMOVAL.

ANY REMNANT FOUNDATION WALL MATERIAL REMOVED SHALL BE CONSIDERED PART OF THE VOLUME OF CONTAMINATED SOILS EXCAVATED FOR THE PURPOSE OF MEASUREMENT FOR PAYMENT.

13.

CONTRACTOR SHALL REMOVE ANY REMNANT FOUNDATION WALLS THAT MAY BE ENCOUNTERED DURING EXCAVATION AT APPROXIMATE LOCATIONS SHOWN ON THIS PLAN TO THE EXTENT NECESSARY FOR THE PURPOSE OF EXCAVATION OF CONTAMINATED SOILS WITHIN THE LIMITS OF EXCAVATION AS PER SPECIFICATION SECTION 02111 - EXCAVATION AND HANDLING OF CONTAMINATED SOILS AND FOR THE PURPOSE OF PROPER SITE RESTORATION AS PER SPECIFICATION SECTION 02402 - SITE RESTORATION AND SPECIFICATION SECTION 02404 - POROUS PAVEMENT SYSTEM.

MW03S/MW03D TO DECOMMISSIONED

ВE

MW07S/MW07D - TO BE DECOMMISSIONED

PROPOSED CONTAMINA
SOIL STAGING AREA

TED

12.

CONTRACTOR SHALL IN EXCAVATIONS ALONG EXFOUNDATION WALLS AS SHEETING AND SHORING. INSTALL SHEETING / EXISTING BUILDINGS / PER SPECIFICATION AND SHORING F S TO PROTECT T NN SECTION 02350

10.

FOR THE O

ALL TRUCKS AND VEHICLES ENTERING AND LEAVING THE SITE SHALL REMAIN ON EXISTING PAVED AND/OR UNPAVED BALLAST COVERED AREAS AT ALL TIMES. IN THE EVENT THAT ACCESS TO AREAS WITHIN THE LIMITS OF DISTURBANCE BECOMES NECESSARY FOR THESE VEHICLES, A STABILIZED CONSTRUCTION ACCESS WITH CRUSHED STONE WHEEL CLEANING TRACKING—PAD SHALL BE INSTALLED AS DETAILED ON PLAN SHEET 8 OF 8 — SOIL EROSION AND SEDIMENT CONTROL DETAILS.

SOIL EROSION AND SEDIMENT CONTROLS, INCLUDING SILT FENCE AROUND ALL EXCAVATION AREAS WITHIN THE UNPAVED BALLAST COVERED AREAS, SHALL BE IMPLEMENTED AS DETAILED ON PLAN SHEET 8 OF 8 — SOIL EROSION AND SEDIMENT CONTROL DETAILS, AND AS PER SPECIFICATION SECTION 01560 — EROSION AND SURFACE WATER CONTROL.

SEDIMENT REMOVAL ON THE SOUTH PORTION OF THE SITE WITHIN THE LIMITS OF DISTURBANCE SHOWN ON THIS PLAN SHALL BE LIMITED TO MAXIMUM DEPTH OF TWO (2) FEET, AS PER SPECIFICATION SECTION 02112 — DREDGING AND HANDLING OF CONTAMINATED SEDIMENTS.

MW01

MONITORING WELL

SUSPECT

TSU

LOCATION

SUSPECT

REMNANT

FOUNDATIONS

WALLS

(APPROX.)

\$ \$ \$ \$ \$

FLOATING

TURBIDITY

BARRIER

MW02S/MW02D TO DECOMMISSIONED

CONCRETE FOUNDATION
TO BE REMOVED

OF SOIL VARIES

DISTURBANCE

— SEE SHEET

4

유

7)

SILT FENCE

LIMIT (TOP

2 OF

F SEDIMENT FEET)

DISTURBANCE

FREEPORT ELECTRIC RIGHT—OF—WAY RESTRICTED AREA (NO EXCAVATION THE PERFORMED IN THIS AREA)

Y (R.O.W.) TO BE

CONTRACTOR SHALL PROVIDE SHEETING SHORING AS NECES (SPECIFICATION SECONS SECONS SHORT SHORT SHEETING/S

TRUCK ROUTE FOR CONTAMINATED LOADOUT / OFFSITE DISPOSAL (TO CONFIRMED BY THE ENGINEER).

SOIL

DROP

CURBING

GUY

WIRE

UTILLITY

POLE

MTH

LIGHT

UNKNOWN MANHOLE

**EXISTING** 

STORM

SEWER

LINE

PROPOSED FIELD OFFICE (TO BE CONFIRMED BY THE ENGINEER)

SANITARY

SEWER

MANHOLE

UTILITY

POLE

(DEAD)

CATCH

BASIN

UTILLITY

POLE

METAL

ETCHING

PROPERTY BOUNDARY

WATER VALVE

METAL

ETCHING

SITE

BOUNDARY

(SITE

#

30-110)

EXISTING

CONTOURS

 $\mathbb{Z}$ 

SOIL EXCAVATION WITHIN THE LIMITS OF DISTURBANCE SHOWN ON THIS PLAN SHALL BE LIMITED TO MAXIMUM DEPTH OF THE LOW TIDE GROUNDWATER TABLE (APPROXIMATELY 5 FEET BELOW GROUND SURFACE), AS DETAILED ON PLAN SHEETS 4 OF 8 — EXCAVATION PLAN AND 7 OF 8 — CONSTRUCTION DETAILS AND AS PER SPECIFICATION SECTION 02111 — EXCAVATION AND HANDLING OF CONTAMINATED SOILS.

CONTRACTOR SHALL PROPERLY DECOMMISSION THE FOLLOWING (6) EXISTING MONITORING WELLS WITHIN THE LIMITS DISTURBANCE: MW02S/MW02D, MW03S/MW03D, , , MW07S/MW07D, AS PER SPECIFICATION SECTION 02670 MONITORING WELL DECOMMISSIONING. AND

STORM SEWER DRAIN OUTFALL


CONTRACTOR SHALL PROVIDE ALL TEMPORARY FACILITIES AND CONTROLS NECESSARY FOR THE WORK AS PER SPECIFICATION SECTION 01500 — TEMPORARY FACILITIES AND CONTROLS.

CONTRACTOR SHALL PERFORM ALL SITE PREPRATION ACTIVITIES, INCLUDING PREPARATION OF GRASS COVERED AREA FOR RIP-RAP PLACEMENT, AS PER SPECIFICATION SECTION 02110 — SITE PREPARATION, CLEARING & GRUBBING. CONTRACTOR SHALL COORDINATE ALL ACTIVITIES AND SCHEDULE WITH THE SITE OPERATOR (AL GROVER'S HIGH & DRY MARINA) AND THE ENGINEER AS PER SPECIFICATION SECTION 01040 — COORDINATION.


GENERAL NOTES: CONTRACTOR SHALL NOT PERFORM ANY EXCAVATION OR INTRUSIVE ACTIVITY WITHIN FREEPORT ELECTRIC RIGHT-OF-WAY (R.O.W.) AREA, AS SHOWN ON THIS PLAN.

FREEPORT ELECTRIC RIGHT-OF-WAY (R.O.W.) RESTRICTED AREA.
NO EXCAVATION TO BE PERFORMED IN THIS AREA.

-WAY

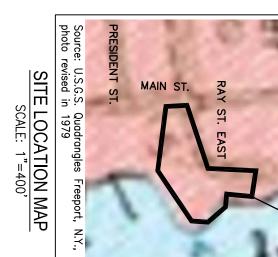

R MAY ENCOUNTER STORM DRAIN CAVATION ACTIVITIES.
R SHALL PROCEED WITH JRING EXCAVATION OPERATIONS I DAMAGE TO STORM DRAIN.

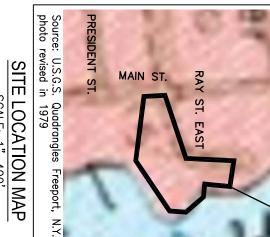


SITE LOCATION

NEW

YORK

BY:

A.R.

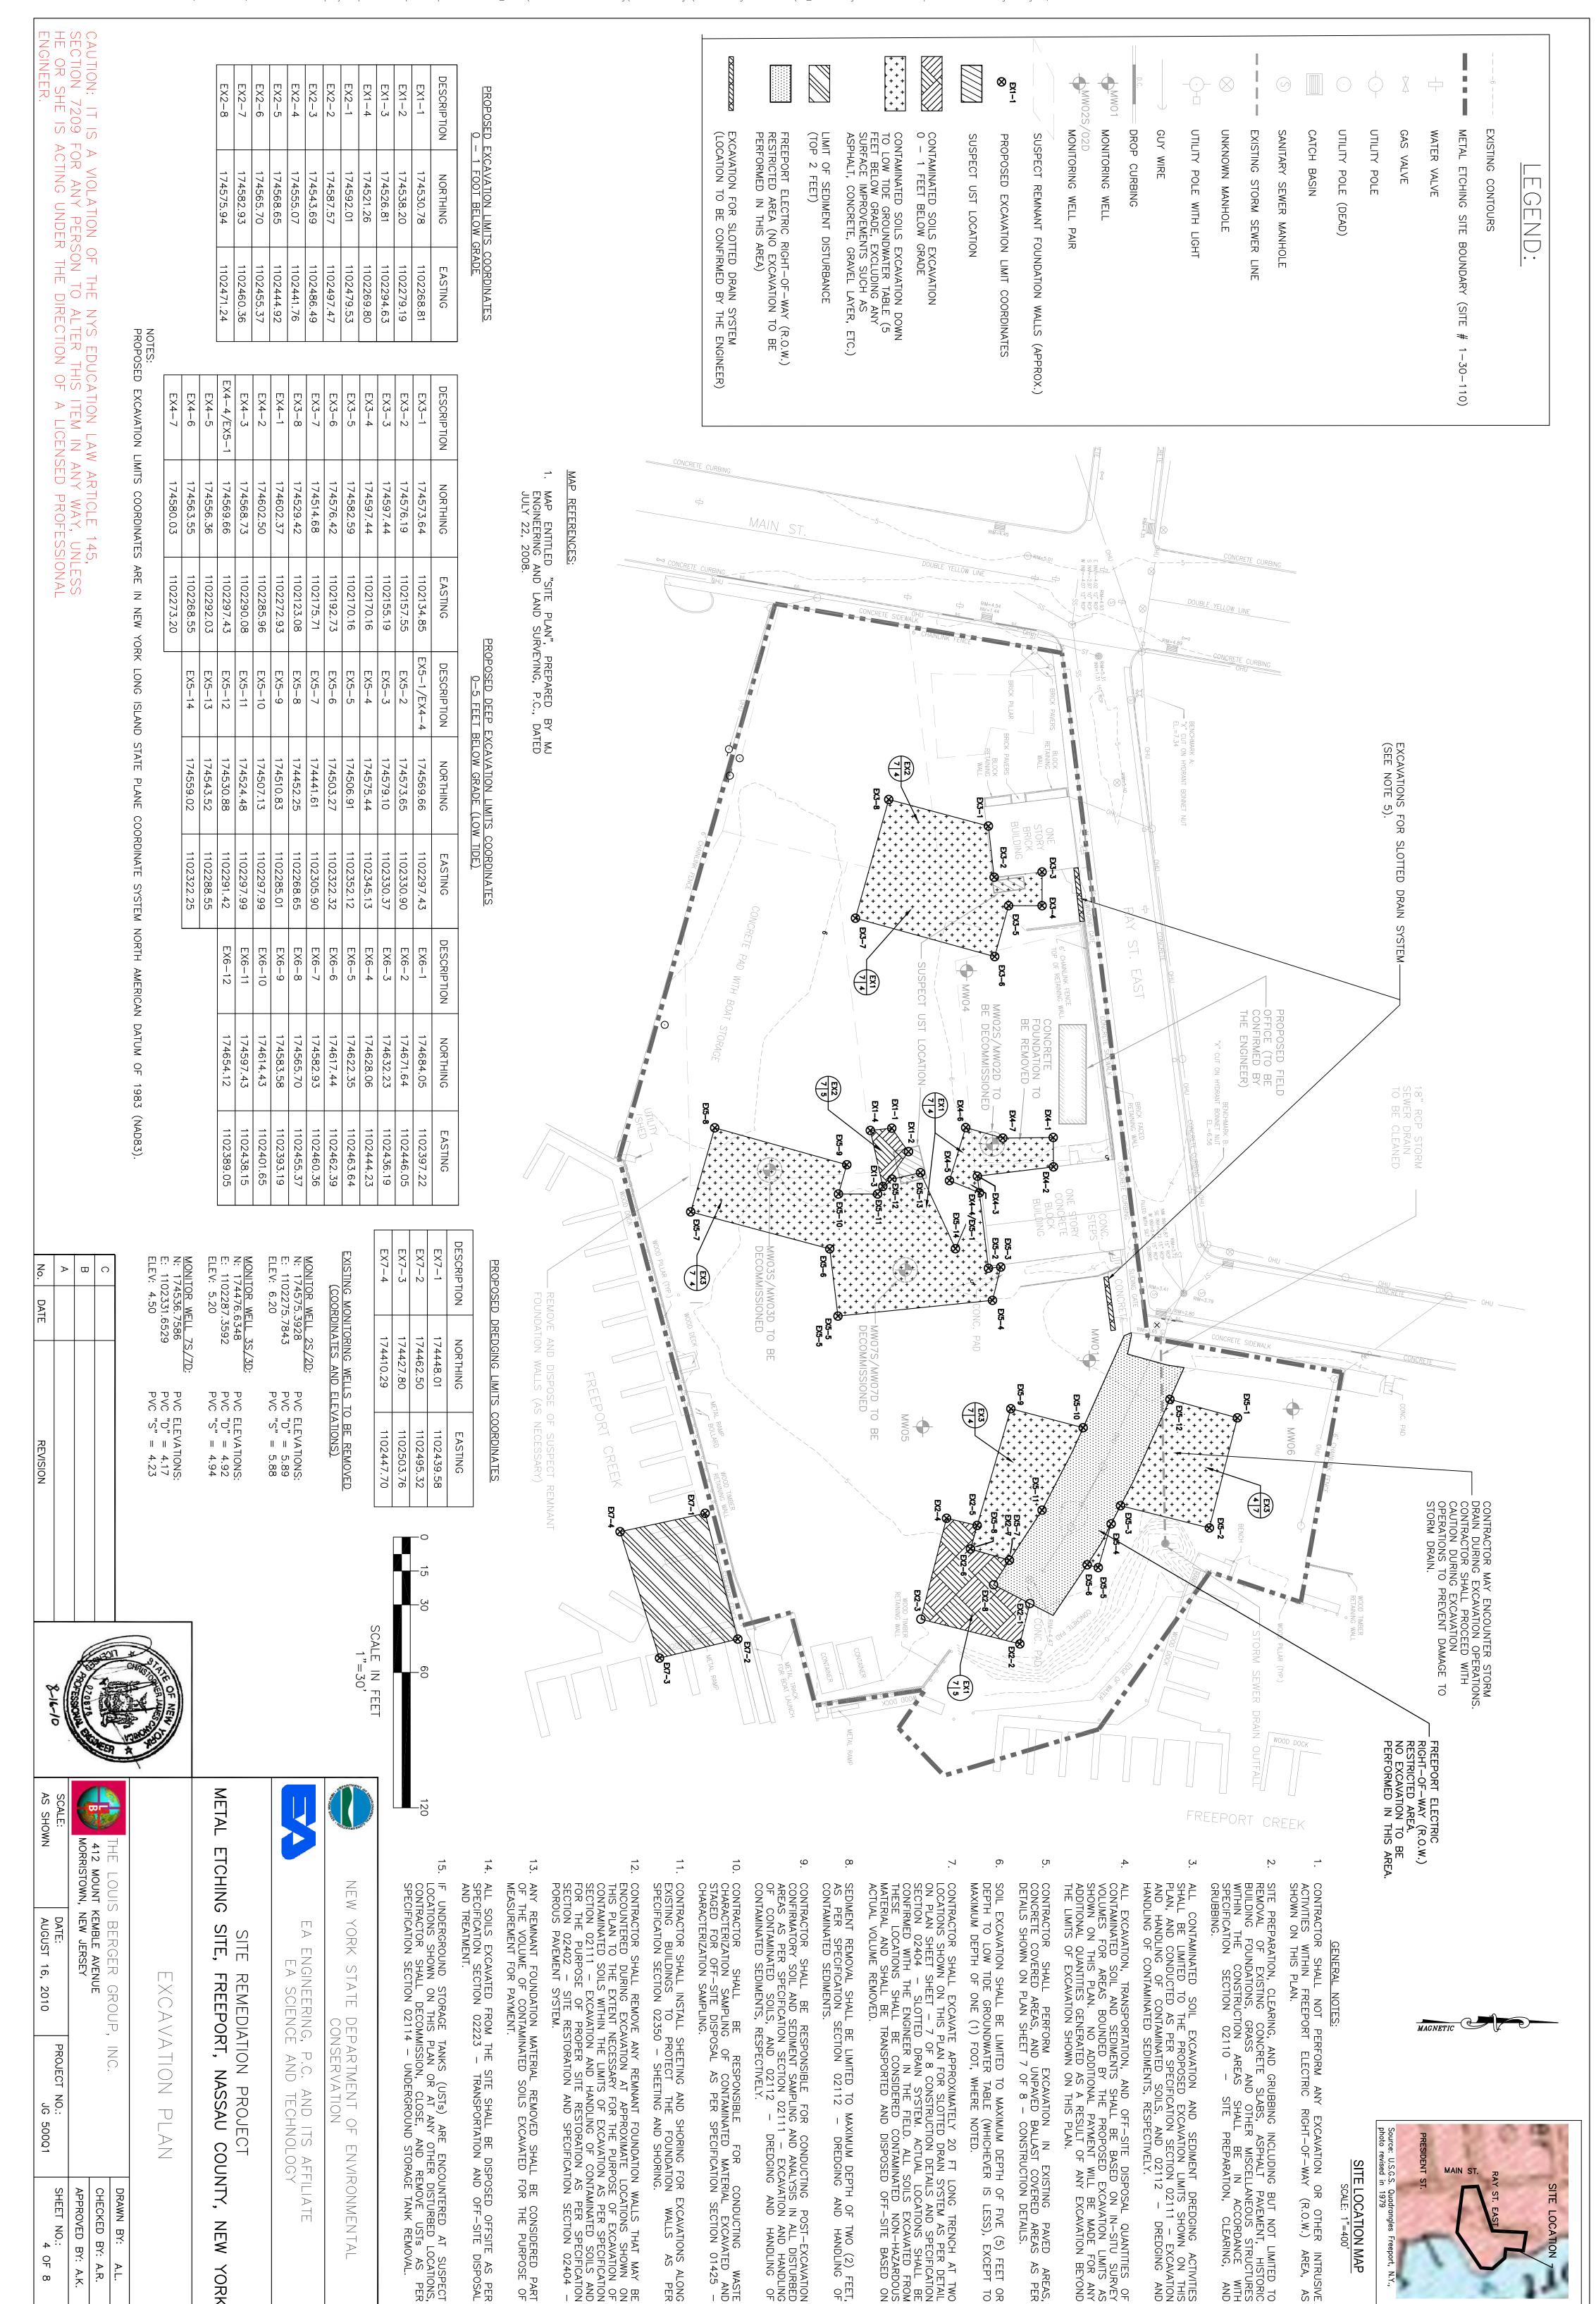

TWO (2) FEET, HANDLING OF

AREAS, AS PER

THE LOUIS BERGER GROUP INC., MORRISTOWN, NJ CADD FILE: G:\Projects\State&Local\NYSDEC\D004441 - Des\_Const\1447428 - Metal Etching\Remedial Design\Metal Design\Metal Etching\Remedial Design\Remedial Design\Metal Etching\Remedial Design\Remedial Design\ CAUTION: IT IS A VIOLATION OF THE NYS EDUCATION LAW ARTICLE 145, SECTION 7209 FOR ANY PERSON TO ALTER THIS ITEM IN ANY WAY, UNLESS HE OR SHE IS ACTING UNDER THE DIRECTION OF A LICENSED PROFESSIONAL ENGINEER. EXISTING VIITILA VIITI EXISTING METAL MONITORING WELL DROP CURBING GUY WIRE UNKNOWN MANHOLE CATCH BASIN UTILITY POLE GAS VALVE WATER VALVE FREEPORT ELECTRIC RIGHT—OF—WAY (R.O.W.) RESTRICTED AREA (NO EXCAVATION TO BE PERFORMED IN THIS AREA) **EXISTING** EXISTING SANITARY PROPOSED CONTOURS PROPOSED POROUS (PERVIOUS) PAVEMENT AREA IN MAXIMUM 5 FEET EXCAVATION AREAS PROPOSED ASPHALT CAP IN EXISTING UNPAVED BALLAST AND MAXIMUM 1 FOOT EXCAVATION AREAS EXISTING UNPAVED BALLAST AREA PROPOSED RIP-RAP SUSPECT REMNANT ETCHING SITE BOUNDARY POLE POLE STORM CONTOURS ASPHALT SEWER MANHOLE CONCRETE COVERED (DEAD) WITH SEWER PAVED LIGHT FOUNDATION LINE AREA (SITE # (APPROX.) 1-30-110) MAP ENTITLED "SITE PLAN", PREPARED ENGINEERING AND LAND SURVEYING, P.C., JULY 22, 2008. REFERENCES: S NN = 2.97 10" RCP W NN = 4.07 12" RCP W NN = 4.07 12" RCP S NN = 2.97 10" RCP W NN = 4.07 12" RCP BY MJ , DATED MW10S/MW10D TO BE INSTALLED MW1 MW09S/MW09D 75 TO BE INSTALLED FREEPORT ELECTRIC RIGHT-OF-WAY (R.O.W.) RESTRICTED AREA.
NO EXCAVATION TO BE PERFORMED IN THIS AREA. METAL THE LOUIS BERGER GROUP, 412 MOUNT KEMBLE AVENUE MORRISTOWN, NEW JERSEY MONITORING **ETCHING** FREEPORT CREEK  $\mathbb{Z}\mathbb{E}\mathbb{W}$ DATE: AUGUST YORK SITE, ENGINEERING, EA SCIENCE STATE 16, REMEDIATION PROJECT FREEPORT, NASSAU CO 2 DEPARTMENT ( MAGNETIC ( CONTRACTOR SHALL RESTORE ALL DISTURBED AREAS TO PRECONSTRUCTION GRADES SHOWN ON THIS PLAN, TO THE EXTENT PRACTICABLE. CONTRACTOR SHALL INSTALL MONITORING WELLS AT THE LOCATION AS INDICATED ON THIS PLAN AND AS SPECIFIED ON SHEET 7 OF 8 — CONSTRCITON DTAILS AND WITHIN SECTION 02671 — MONITORING WELL INSTALLATION OF THE CONTRACT DOCUMENTS. CONTRACTOR SHALL REMOVE 12-INCHES OF EXISING BALLAST MATERIAL PROIOR TO INSTALLING ASPHALT COVER (REFER TO SHEET 6 OF 8 - SITE RESTORATION AND STORMWATER MANAGEMENT PLAN. BALLAST MATERIAL REMOVED SHALL BE USED AS EXCAVATION BACKFILL. CONTRACTOR SHALL NOT PLACE ANY RESTORATION MATERIALS, FILL OR COVER WITHIN THE FREEPORT ELECTRIC RIGHT-OF-WAY. GRADING AND INSTALLATION PROJECT NO.: GRADING  $\mathbb{Z}$ P.C. AND ITS AFFILIATE TECHNOLOGY SCALE IN FEET 1"=30"  $\bigcap_{i=1}^{n}$ 500Q1 Source: U.S.G.S. photo revised in COUNTY, ENVIRONMENTAL SITE LOCATION MAP

SCALE: 1"=400' SITE LOCAT DRAWN BY: ,

APPROVED BY: A.K.

OF 8

A.R.

NEW

YORK

AND ITS AFFILIATE TECHNOLOGY

PLAN

CHECKED BY:

A.R.

DRAWN BY:

APPROVED BY: A.K.

COUNTY,


NEW


YORK

 $\bigcirc \vdash$ 

ENVIRONMENTAL

THE LOUIS BERGER GROUP INC., MORRISTOWN, NJ CADD FILE: G:\Projects\State&Local\NYSDEC\D004441 — Des\_Const\1447428 — Metal Etching\Remedial Design\Metal Etching RD — 100%\ME\_100% Design P6 0F 8 — Site Restoration Plan.dwg Aug 16, 2010 CAUTION: IT IS SECTION 7209 HE OR SHE IS ENGINEER. NIILI EXISTING CATCH VIILI UTILLITY METAL EXISTING MONITORING WELL GAS WATER HAY BALES , (TO REMAIN RESTORED) DROP CURBING UNKNOWN MANHOLE SANITARY EXISTING EXISTING FREEPORT ELECTRIC RIGHT—OF—WAY (R.O.W.) RESTRICTED AREA (NO EXCAVATION TO BE PERFORMED IN THIS AREA) PROPOSED POROUS (PERVIOUS) PAVEMENT AREA IN MAXIMUM 5 FEET EXCAVATION AREAS PROPOSED ASPHALT CAP IN EXISTING UNPAVED BALLAST AND MAXIMUM 1 FOOT EXCAVATION AREAS PROPOSED EXISTING UNPAVED BALLAST AREA PROPOSED SUSPECT REMNANT IS A VIOLATION OF THE NYS EDUCATION LAW FOR ANY PERSON TO ALTER THIS ITEM IN ANY ACTING UNDER THE DIRECTION OF A LICENSED F VALVE **WIRE** FENCE ETCHING BASIN VALVE POLE POLE STORM CONTOURS SEWER CONCRETE ASPHALT SLOTTED RIP-RAP ALONG PROPOSED POROUS PAVEMENT IN PLACE UNTIL ALL OTHER AREAS (DEAD)  $\mathbb{A}$ SITE BOUNDARY MANHOLE SEWER LINE PAVED FOUNDATION COVERED DRAIN SYSTEM (SITE WALLS # (APPROX.) AREA V ARTICLE 145, Y WAY, UNLESS PROFESSIONAL MAP ENTITLED "SITE PLAN", PREPARED ENGINEERING AND LAND SURVEYING, P.C., JULY 22, 2008. REFERENCES: N N D 000 RES2 000 CONTRACTOR SHALL INSTALL SLOTTED DRAIN SYSTEM AT THESE TWO LOCATIONS (TO BE CONFIRMED BY THE ENGINEER). REFER TO PLAN SHEET SHEET - 7 OF 8 CONSTRUCTION DETAILS AND AS SPECIFICATION SECTION 02404 - SLOTTED DRAIN SYSTEM. INSTALL HAY BALES PROPOSED POROUS — PAVEMENT AREA RES3 PROPOSED ASPHALT CAP AREA SCALE IN FEET 1"=30" SILT FENCE (TYP.) METAL FREEPORT ELECTRIC
RIGHT-OF-WAY (R.O.W.)
RESTRICTED AREA.
NO EXCAVATION TO BE
PERFORMED IN THIS AREA. THE LOUIS BERGER GROUP, 412 MOUNT KEMBLE AVENUE MORRISTOWN, NEW JERSEY **ETCHING** FREEPORT CREEK  $\mathbb{Z} \mathbb{E} \, \mathbb{V}$ STORMWATER ORARILY FOR ACE BACK IN ION UPON DIRECTED BY YORK SITE, SITE ENGINEERING, EA SCIENCE STATE REMEDIATION PROJECT FREEPORT, NASSAU CO 5 3. ? S. CONTRACTOR SHALL PLACE HAY BALES AROUND SLOTTED DRAIN SYSTEMS AFTER CONSTRUCTION WHERE PRACTICAL. AT LOCATIONS WHERE VEHICULAR ACCESS ARE NECESSARY, SLOTTED DRAIN SYSTEMS SHALL BE INSTALLED AFTER ALL RESTORATION ACTIVITIES (TO THE EXTENT FEASIBLE) AND COVERED WITH PROPERLY SECURED PLASTIC SHEETS THROUGH THE COMPLETION OF ALL SITE RESTORATION ACTIVITIES. 3. CONTRACTOR SHALL PLACE AND MAINTAIN HAY BALES OR SILT FENCE AROUND THE PERIMETER OF ALL PROPOSED POROUS PAVEMENT AREAS PRIOR TO THE CONSTRUCTION OF THE FINAL 3—INCH POROUS PAVEMENT LAYER. THE HAY BALES OR SILT FENCE SHALL REMAIN IN PLACE UNTIL ALL OTHER AREAS AT THE SITE ARE RESTORED AND SURFACES HAVE BEEN CLEANED OF SEDIMENTS.  $\bigcirc$ DEPARTMENT (
CONSERVATION CONTRACTOR SHALL RESTORE SLOTTED DRAIN SYSTEM EXCAVATION AREAS IN ACCORDANCE WITH DETAIL ON PLAN SHEET 7 OF 8 — CONSTRUCTION DETAILS, AND AS PER SPECIFICATION SECTION 02404 — SLOTTED DRAIN SYSTEM. CONTRACTOR SHALL RESTORE ALL AREAS EXCAVATED TO A MAXIMUM DEPTH OF 5 FEET AS DETAILED ON PLAN SHEET 7 OF 8 — CONSTRUCTION DETAILS AND AS PER SPECIFICATION SECTION 02400 — EARTHWORK AND FILL MATERIALS AND SECTION 02404 — POROUS PAVEMENT SYSTEM. CONTRACTOR SHALL BE RESPONSIBLE FOR RESTORING ANY AREAS OUTSIDE OF CONSTRUCTION AREAS DAMAGED DURING WORK ACTIVITIES TO PRE-EXISTING CONDITIONS. CONTRACTOR SHALL RESTORE THE GRASS COVERED AREA AS DETAILED ON PLAN SHEET 7 OF 8 — CONSTRUCTION DETAILS, AND AS PER SPECIFICATION SECTION 02402 — SITE RESTORATION. CONTRACTOR SHALL RESTORE UNDISTURBED UNPAVED BALLAST COVERED AREAS EXCEPT FOR THE FREEPORT ELECTRIC RIGHT—OF—WAY (R.O.W.) AREA, AS DETAILED ON PLAN SHEET 7 OF 8—CONSTRUCTION DETAILS, AND AS PER SPECIFICATION SECTION 02402—SITE RESTORATION. CONTRACTOR SHALL RESTORE ALL AREAS EXCAVATED TO A MAXIMUM DEPTH OF 1 FOOT AS DETAILED ON PLAN SHEET 7 OF 8 — CONSTRUCTION DETAILS AND AS PER SPECIFICATION SECTION 02402 — SITE RESTORATION. CONTRACTOR SHALL RESTRICT VEHICULAR ACCESS TO ALL HAY BALES OR SILT FENCE COVERED PROPOSED POROUS PAVEMENT AREAS, AND SHALL LIMIT VEHICULAR ACCESS TO THE EXTENT FEASIBLE TO THE PROPOSED POROUS PAVEMENT AREAS DURING ALL STAGES OF ITS CONSTRUCTION. MANAGEMENT TORATION Z .. PROJECT NOTES: P.C.

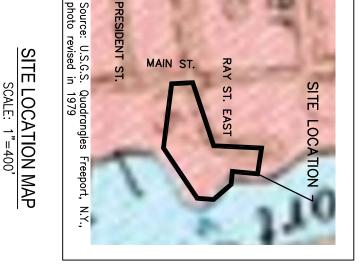

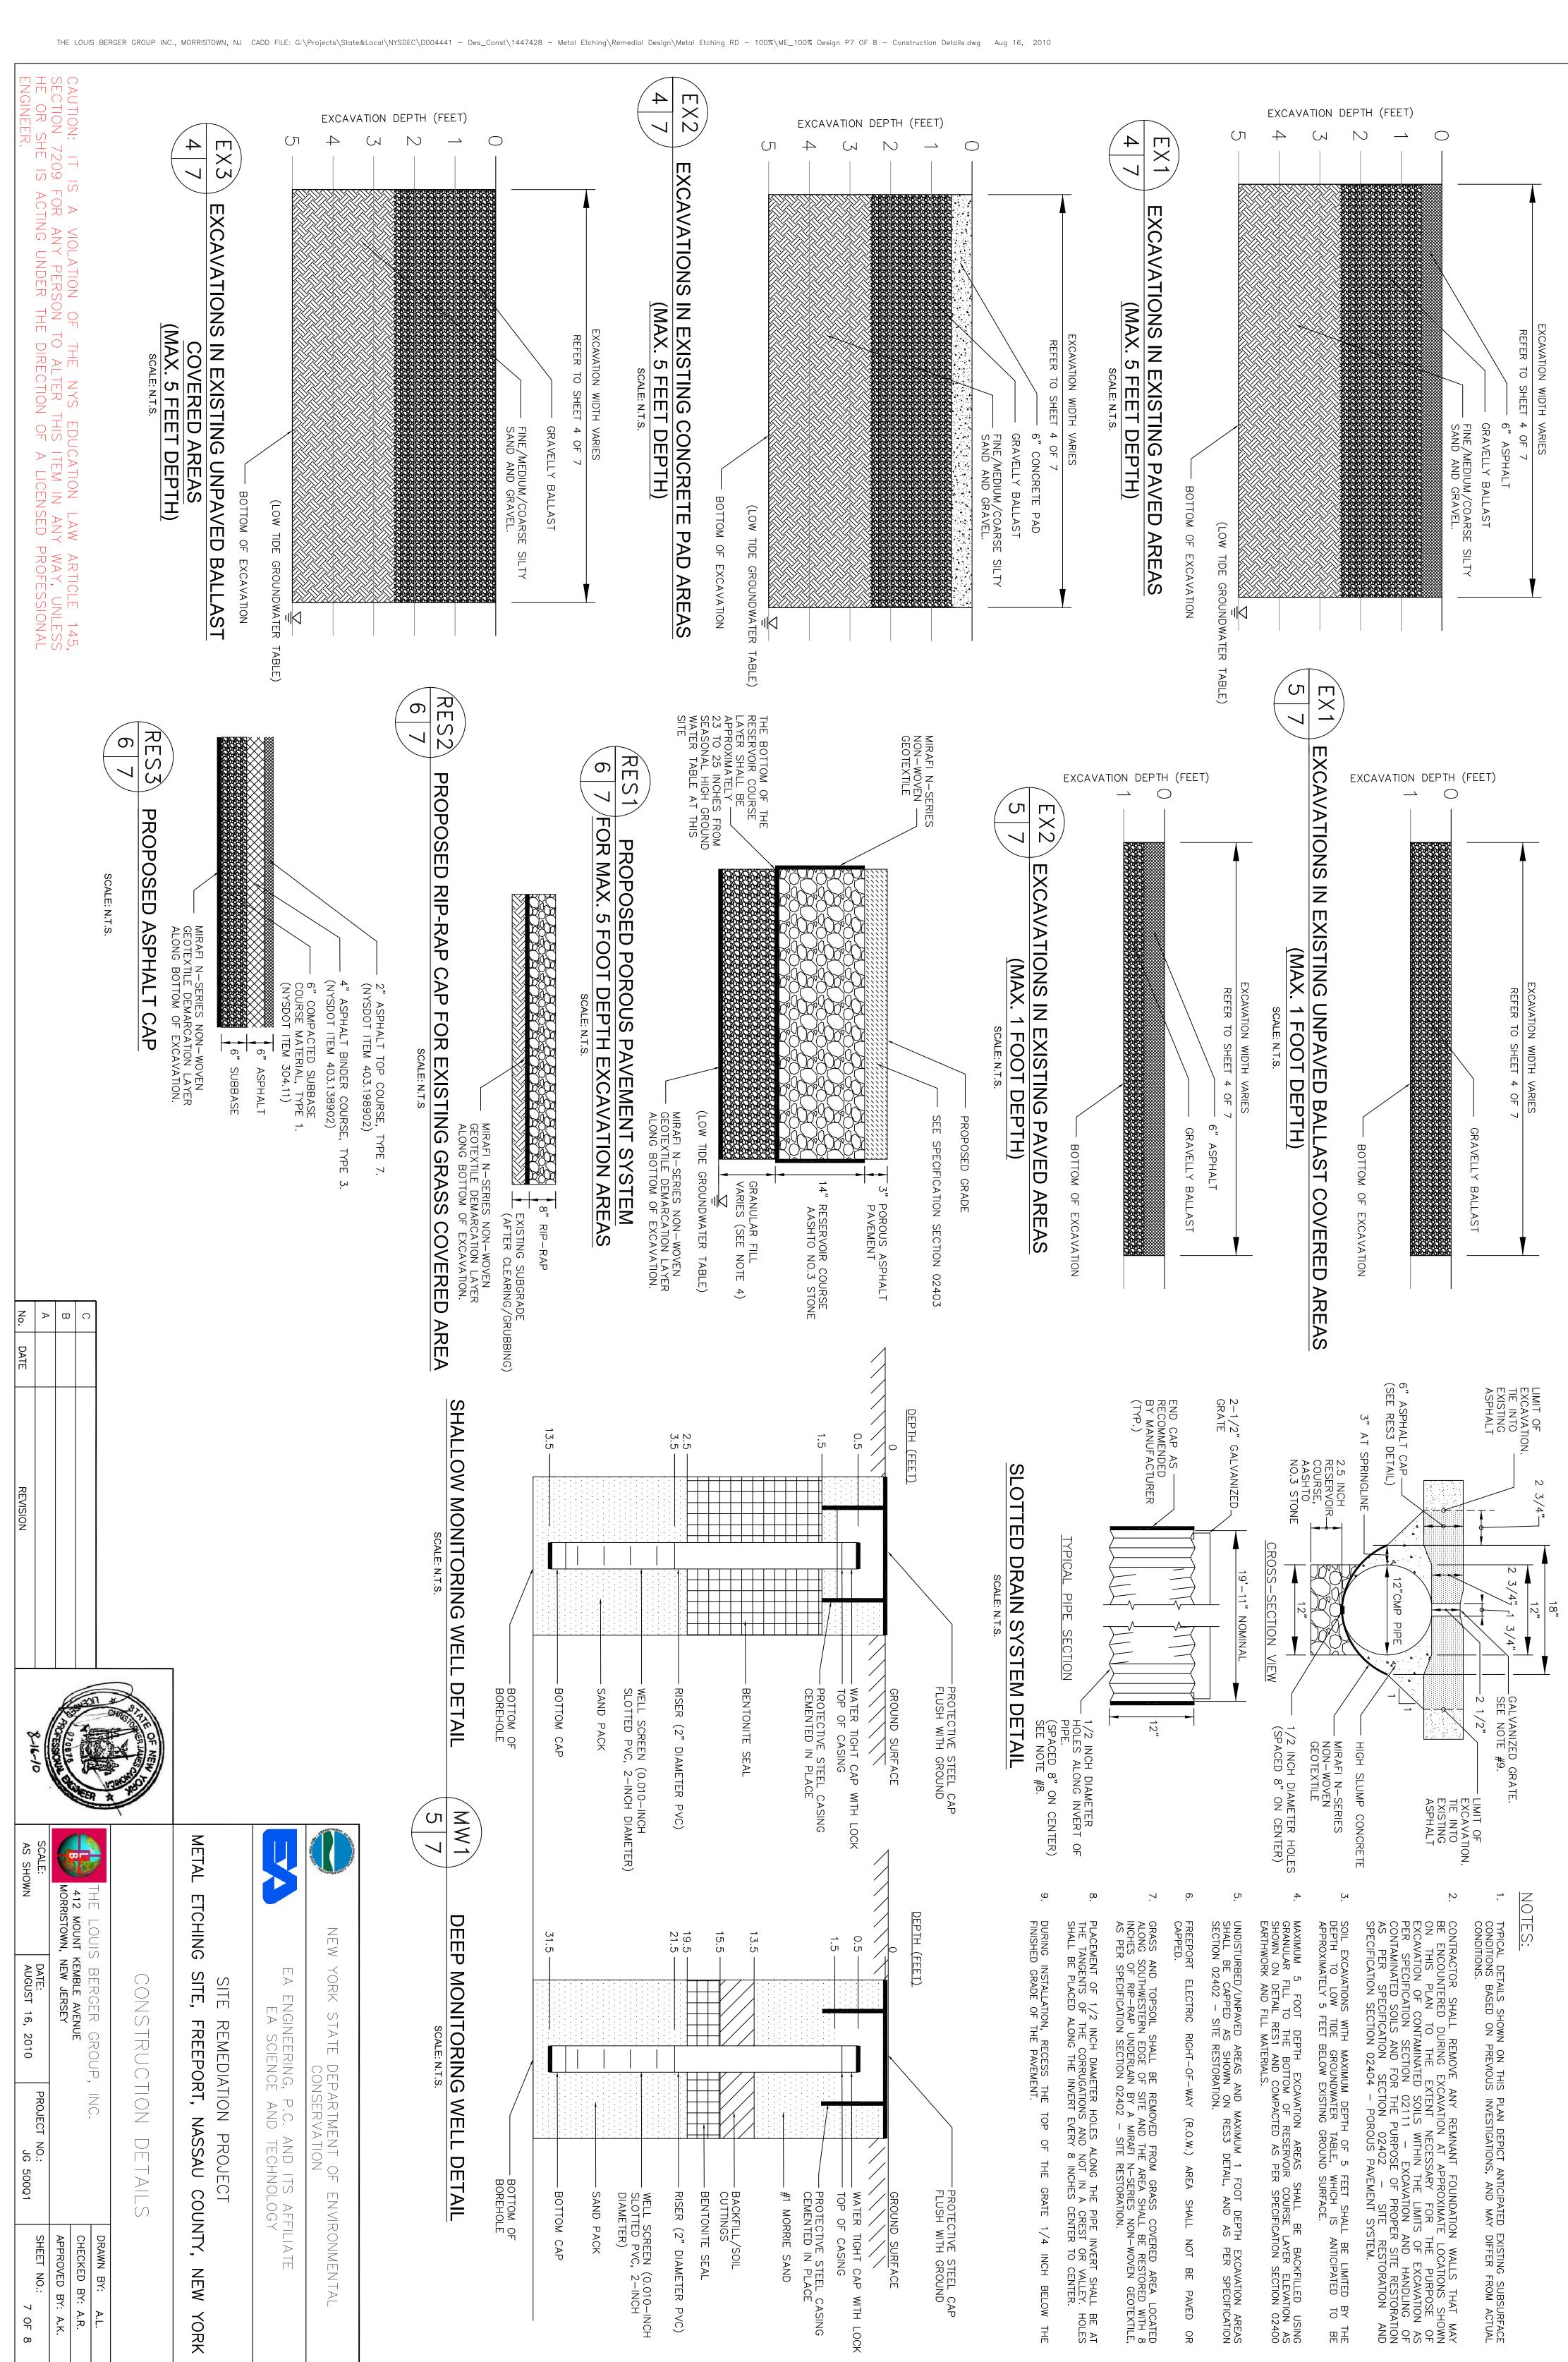


BODY OF WATER DISCHARGE POINT

SHORE

LINE

OR DIK

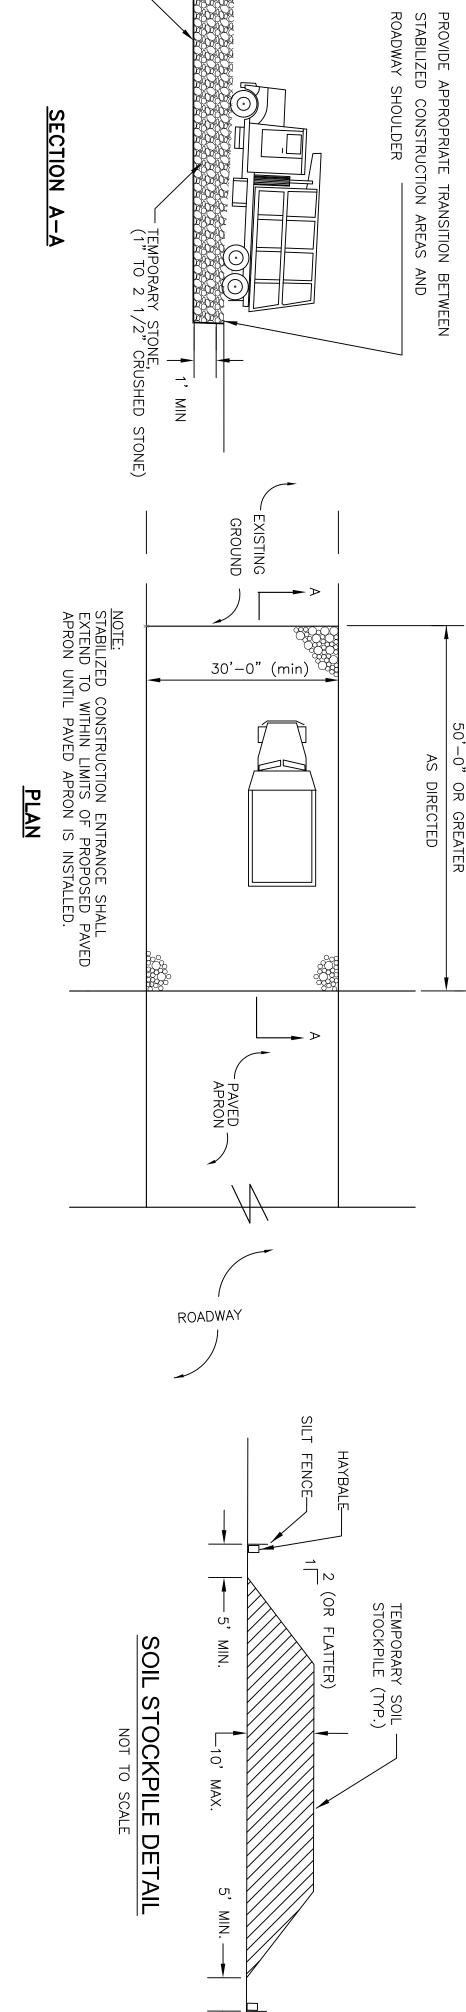

MIRAFI N-SERIES NON-WOVEN GEOTEXTILE

EXISTING GRADE

6.

MAXIMUM SOIL SLOPES SHALL NOT EXCEED 2:1 UNLESS ADDITIONAL MEASURES ARE TAKEN AND APPROVED BY THE APPROPRIATE SOIL CONSERVATION DISTRICT. THESE "SPECIAL" MEASURES SHALL BE DESIGNED BY THE APPLICANT'S ENGINEER.

ALL TRUCKS AND VEHICLES FREQUENTLY ENTERING AND LEAVING THE SITE SHALL REMAIN ON EXISTING PAVED AND/OR EXISTING BALLAST COVERED AREAS AT ALL TIMES. IN THE EVENT THAT ACCESS TO AREAS WITHIN THE LIMITS OF DISTURBANCE BECOMES NECESSARY FOR THESE VEHICLES, A CRUSHED STONE WHEEL CLEANING TRACKING—PAD SHALL BE INSTALLED TO ACCESS SUCH AREAS USING 2—1/2" CRUSHED STONE TO A MINIMUM LENGTH OF 50 FEET.

ASPHALT PAVED AREAS AND CONCRETE COVERED AREAS MUST BE KEPT CLEAN AT ALL TIMES. DO NOT UTILIZE A FIRE OR GARDEN HOSE TO CLEAN AREAS UNLESS THE RUNOFF IS DIRECTED TO A PROPERLY DESIGNED AND FUNCTIONING SEDIMENT BASIN. ALL PUMP DEWATERING OPERATIONS SHALL BE DIRECTED TOWARD A FUNCTIONING SEDIMENT BASIN, IF INSTALLED.

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?

ALL STORM DRAINAGE INLETS SHALL BE PROTECTED BY ONE OF THE PRACTICES ACCEPTED IN THE STANDARDS AND REMAIN UNTIL PERMANENT STABILIZATION HAS BEEN ESTABLISHED. STORM DRAINAGE OUTLET POINTS SHALL BE PROTECTED AS REQUIRED BEFORE THEY BECOME FUNCTIONAL.

EROSION CONTROL DEVICES SHALL BE PERIODICALLY INSPECTED, MAINTAINED CORRECTED BY THE CONTRACTOR. ANY DAMAGE INCURRED BY EROSION LL BE RECTIFIED IMMEDIATELY.

**∴** 

SOIL EROSION AND SEDIMENT CONTROL DETAILS PROVIDED ON THIS PLAN ARE TYPICAL DETAILS PROVIDED FOR GUIDANCE PURPOSE ONLY. THE CONTRACTOR SHALL BE RESPONSIBLE FOR DEVELOPING APPROPRIATE DETAILS FOR THE PURPOSE OF PREPARING AND SUBMITTING A STORMWATER POLLUTION PREVENTION PLAN (SWPPP) TO THE VILLAGE OF FREEPORT WHO WILL COORDINATE LOCAL AND DEPARTMENT APPROVAL, AND TO THE ENGINEER.


SOIL

EROSION AND

SEDIMENT CONTROL

NOTES

## STABILIZED CONSTRUCTION ACCESS TO DISTURBANCE AREAS (IF NECESSARY)

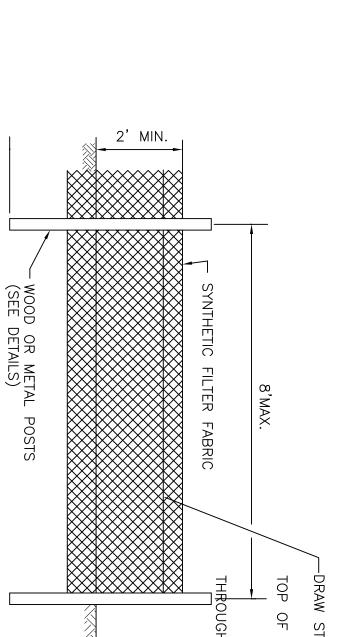

FABRIC SECURED TO POST — WITH METAL FASTENERS AND REINFORCEMENT BETWEEN FASTENER AND FABRIC

FENCE POST 8-FOOT ON CENTERS

DIRECTION OF FLOW


2' MIN.


EXCAVATE TRENCH,— BURY BOTTOM 6" OF FABRIC, TAMP IN PLACE


POST (SEE DETAIL)

SILT FENCE

NOT TO SCALE

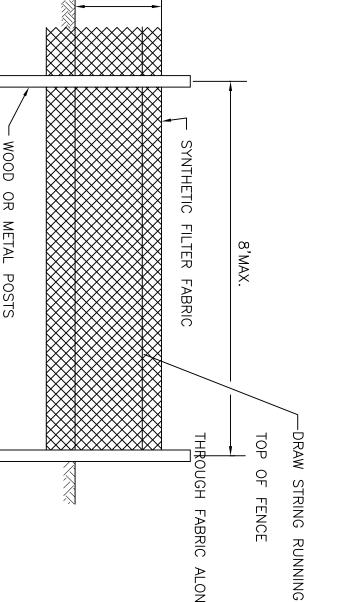

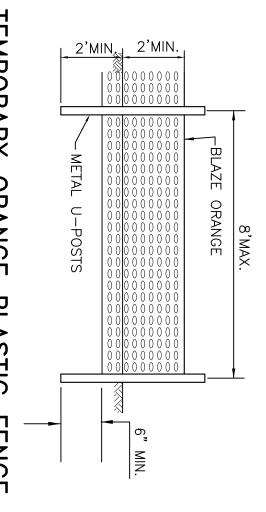


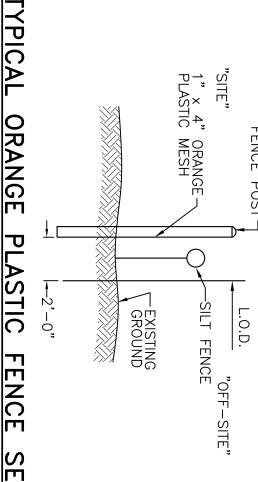



TEMPORARY ORANGE **PLASTIC** FENCE

TYPICAL AT LIMIT OF PLASTIC FENCE OF DISTURBANCE

## ORANGE PLASTIC FENCE DETAILS NOT TO SCALE

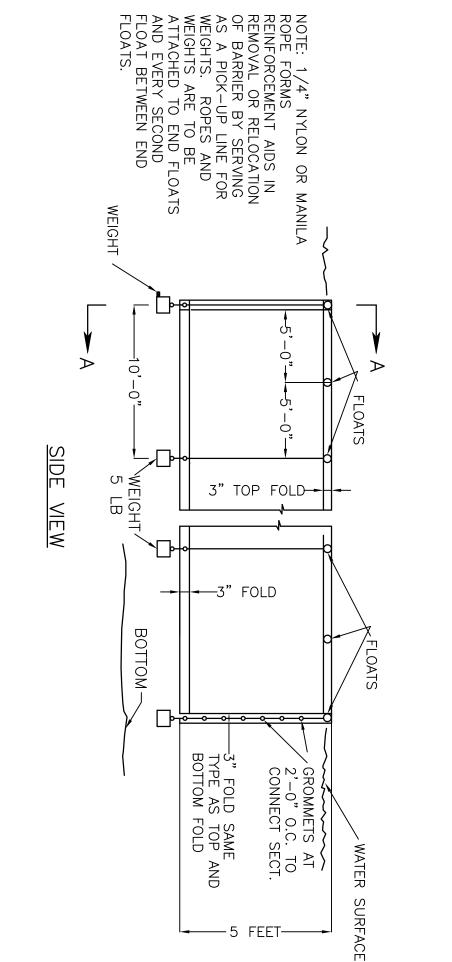

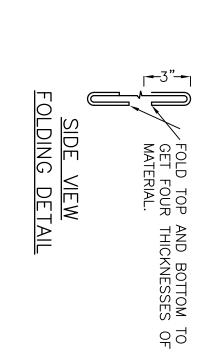

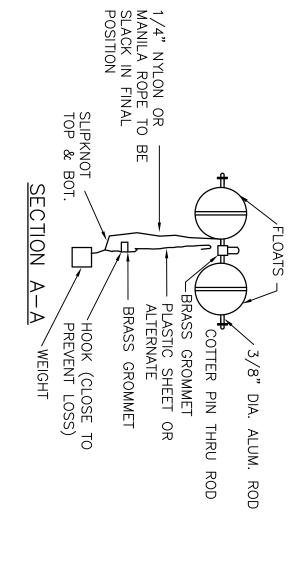

FLOATING TURBIDITY BARRIER NOT TO SCALE

?

EXACT PLACEMENT OF TURBIDITY BARRIER SHALL BE LOCATED AS EFFECTIVELY CONTROL SILT DISPERSION UNDER SITE CONDITIONS.

PLACE TURBIDITY BARRIER TO PREVENT DRIFTING OF CAUSED BY DISCHARGE DURING CONSTRUCTION, DREDGING OR FILLING OPERATIONS.

SILT

3.

SUITABLE ALTERNATE MAY BE FASTENED TO STAKES INTO THE BOTTOM IN LIEU OF FLOATS AND WEIGHTS

DRIVEN


NOTES:

TYPICAL APPLICATION

WET EXCAVATION OR BRIDGE STRUCTURE. (WET)

SUBMARINE

CABLE

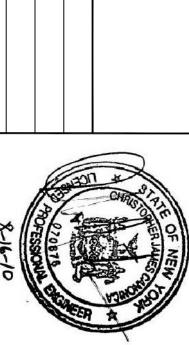

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CAUTION: IT IS SECTION 7209 HE OR SHE IS ENGINEER.

IS A VIOLATION OF THE NYS EDUCATION LAW ARTICLE 145, FOR ANY PERSON TO ALTER THIS ITEM IN ANY WAY, UNLESS ACTING UNDER THE DIRECTION OF A LICENSED PROFESSIONAL

8-16-10	TO PESSONAL OF THE PARTY OF THE	A SERVICE OF NEW
SCALE:	THE LOU 412 MOUN MORRISTOW	SOIL ERO

	OTESSOUP OF	ST CHRO	S. P. LE OF NEW
SON E.	B		SO
	412 MOU MORRISTOV		

METAL

**ETCHING** 

SITE,

FREEPORT,

NASSAU COUNTY,

NEW

YORK

SITE

REMEDIATION PROJECT

 $\mathbb{Z}$ 

YORK

STATE

DEPARTMENT OF CONSERVATION

ENVIRONMENTAL

 $\nearrow$ 

ENGINEERING, EA SCIENCE

P.C.

AND ITS AFFILIATE TECHNOLOGY

			SOIL
412 MOUNT KEMBLE AVENUE		THE LOUIS BERGER GROUP INC	EROSION AND SEDIMENT CONTRO
	,		

MROSION
CONTROL
DETAILS

OWN:				
Z	MORRISTOWN, NEW JERSEY	412 MOUNT	THF   01110	
DATE: AUGUST 16, 2010	NEW JERSEY	412 MOUNT KEMBLE AVENUE	THE LOUIS BERGER GROUP INC	
PROJECT NO.: JG 500Q1				
SHEET NO.: 8 OF 8	APPROVED BY: A.K.	CHECKED BY: A.R.	DRAWN BY: A.L.	