NEW YORK STATE DEPARTMENT OF ENVIRONMENTAL CONSERVATION DIVISION OF ENVIRONMENTAL REMEDIATION

# THREE STAR ANODIZING SITE NYSDEC SITE 314058

WAPPINGERS FALLS DUTCHESS COUNTY, NEW YORK


# **JU-1 REMEDIAL CONSTRUCTION** CONTRACT DRAWINGS

CONTRACT D008793

INDEX TO DRAWINGS

HEET NO.



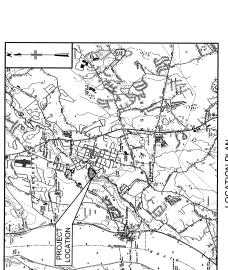

LOCATION PLAN
APPROXIMATE SCALE: 1"=1000







CONSULTING ENGINEERS

APPROVED FOR MALCOLM PIRNIE

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# NOTES:

- 1. ALL CONSTRUCTION OPERATIONS SHALL BE ACCOMPLISHED IN ACCORDANCE WITH APPLICABLE OSHA STANDARDS. COPIES OF OSHA'S STANDARDS MAY BE PURCHASED FROM THE U.S. GOVERNMENT PRINTING OFFICE. THE CONTRACTOR ALONE MIL BE RESPONSIBLE FOR THE EXECUTION OF THE WORK IN ACCORDANCE ALL APPLICABLE HEALTH AND SAFTLY REQUIREMENTS, THE OWNER NOR THE ENGNEER SHALL INSPECT THE WORK OR THE WIETHOSS OF CONSTRUCTION FOR COMPLIANCE WITH THESE REQUIREMENTS.
- 2. EXISTING BASEMAP COMPILED BY YEC, INC., VALLEY COTTAGE, NY, DATED JANUARY 2011.


STONE WALL

- 3. CONTRACTOR SHALL FILL VIGREY ALL DIMENSIONS AND CONDITIONS BEFORE COMMENCING WORK. IT IS THE CONTRACTORS RESPONSIBILITY TO REPORT AND VIGSEPANCES TO BENDERE AND OWNER IN A TIMEN IN MANNER. FALURE TO PROSPECT IN ADVANCE OF WORK OR VERIFY DIMENSIONS SHALL NOT BE CAUSE FOR ADDITIONAL COSTS TO THE OWNER.
- CONTRACTOR SHALL BE RESPONSIBLE FOR ALL PERMITS WHICH ARE REQUIRED PRIOR TO CONSTRUCTION, EXCEPT AS NOTED OTHERWISE IN THE CONTRACT DOCUMENTS.
- 5. REFER TO SPECIAL CONSTRUCTION CONDITIONS, SECTION 01 11 15.
- CONTRACTOR SHALL PREPARE, IMPLEMENT, AND CONFORM TO THE STORM WATER POLLUTION PREVENTION PLAN (SWPPP) AS APPROVED BY NYSDEC.
- CONTRACTOR SHALL CONFORM TO THE REQUIREMENTS FOR EARTHWORK AND DUST CONTROL FOR ALL SITE OPERATIONS.
- 8. CONTRACTOR SHALL CONFINE ALL WORK, INCLUDING ACCESS, STAGING, AND STORAGE OF EQUIPMENT AND MACHINERY TO THE BOUNDARIES SHOWN.
- 9. THE CONTRACTOR SHALL PROVIDE ALL LABOR, MATERIALS, EQUIPMENT AND INCIDENTAL ITEMS REQUIRED TO MAINTAIN AND REPLACE ANY UTILITIES DISTURBED DURING THE CONSTRUCTION.
- 10. THE CONTRACTOR SHALL IMMEDIATELY INFORM THE ENGINEER IF UTILITIES ARE DISTURBED AND THE CONTRACTOR SHALL IMMEDIATELY REPAIR THE UTILITY PRIOR TO CONTINUING WORK.
- 11. SCALES SHOWN HEREIN ARE FOR FULL SIZE PLOTS ON 22x34 INCH SHEETS. THE CONTRACTOR IS RESPONSIBLE FOR CONVERTING SCALES ON REDUCED OR ENLARGED PLOTS.

# SECTION AND DETAIL KEY

SECTION NUMBER (CONSECUTIVELY NUMBERED ON SHEET SECTION IS LOCATED)-SHEET ON WHICH-SECTION IS FIRST REFERENCED SECTION CALLOUTS DETAIL NUMBER (CONSECUTIVELY NUMBERED ON SHEET DETAIL IS LOCATED) -SHEET ON WHICH-DETAIL IS FIRST REFERENCED SHEET ON WHICH DETAIL IS SHOWN DETAIL CALLOUTS



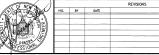

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NEW YORK STATE DEPT. OF ENVIRONMENTAL CONSERVATION DIVISION OF ENVIRONMENTAL REMEDIATION OU—1 REMEDIAL CONSTRUCTION 3 STAR ANODIZING SITE NYSDEC SITE 314058, CONTRACT D008793

CONTRACT DRAWINGS

GENERAL NOTES, LEGEND AND KEY MAP

ARCADIS OF NEW YORK, INC.


NAPPINGER CREEK AXTON CROSS BUILDING AREA LAGOON AREA-MGP AREA VAT AREA LOWER RACEWAY AREA KEY MAP OF AREAS

30 0 30 60


SCALE: AS SHOWN

APRIL 2013 SHEET 1 OF 4

0266386G01

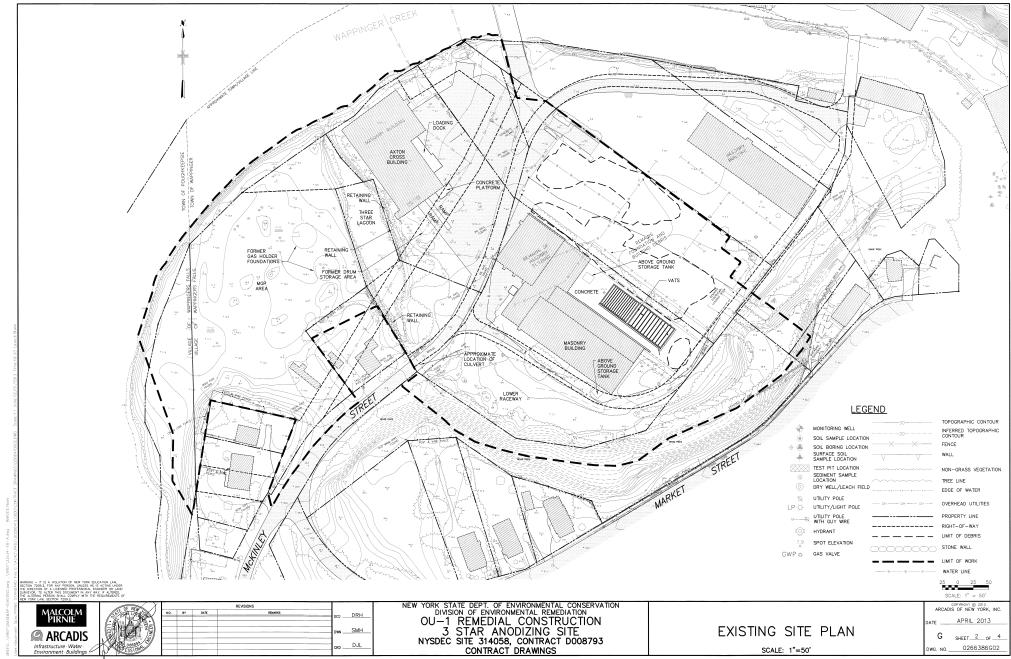


# ACCESS ROAD/PAD DETAIL NOT TO SCALE

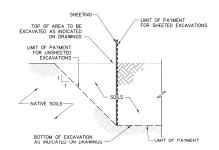

# PAYMENT LIMIT - EXCAVATION AND BACKFILL OF SOILS


NOT TO SCALE

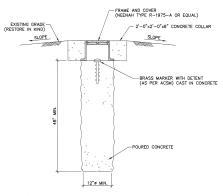

### NOTE

CONTRACTOR SHALL INSTALL AND ESTABLISH CONTROL AT (3) SURVEY MONUMENTS AT LOCATIONS COORDINATED WITH ENGINEER.

# SURVEY MONUMENT DETAIL NOT TO SCALE

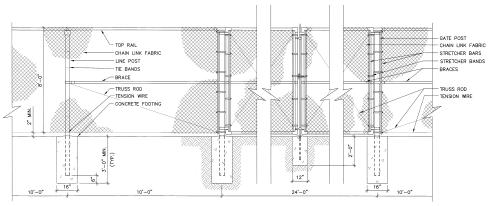

# DOUBLE GATE AND FENCE DETAIL

NOT TO SCALE

MALCOLM PIRNIE

ARCADIS

Infrastructure - Water

Environment - Buildings



NEW YORK STATE DEPT. OF ENVIRONMENTAL CONSERVATION
DIVISION OF ENVIRONMENTAL REMEDIATION
OU—1 REMEDIAL CONSTRUCTION
3 STAR ANODIZING SITE
NYSDEC SITE 314058, CONTRACT D008793
CONTRACT DRAWINGS

GENERAL DETAILS I

NOT TO SCALE

ARCADIS OF NEW YORK, INC.


DATE \_\_\_\_\_APRIL\_2013


G \_\_\_\_SHEET\_\_3\_OF\_\_4

DWG, NO.\_\_\_0266286G03

# GENERAL EROSION AND SEDIMENT CONTROL NOTES:

- ALL WORK SHALL BE DONE IN ACCORDANCE WITH THE NEW YORK QUIDELINES FOR URBAN EROGION AND SCOMENT CONTROL, CURRENT EDTION, CONTRACTOR SHALL COMEN' WITH ALL APPLICABLE STORWANTER PERMITS, INCLUDION THE INVISEO SPIES CENERAL PERMIT FOR STORWANTER DISCHARGES FROM CONSTRUCTION ACTIVITIES, AND WITH THE REQUIREMENTS OF THE APPROVED STORWANTER POLLUTION PREVENTION PLACE.
- ALL SOIL EROSION AND SEDIMENT CONTROL PRACTICES SHALL BE INSTALLED PRIOR TO ANY SOIL DISTURBANCE, AND MAINTAINED UNTIL PERMANENT PROTECTION IS ESTABLISHED. CONTRACTOR SHALL INSPECT AND REPAIR SEDIMENT AND EROSION CONTROL MEASURES DAILY.
- 3. UPON COMPLETION OF FINAL GRADING, IF THE SEASON PREVENTS THE ESTABLISHMENT OF A PERMANENT COVER, THE DISTURBED AREA WILL BE TEMPORARILY SEEDED IN ACCORDANCE WITH THE CONTRACT SPECIFICATIONS.
- PERMANENT VEGETATION TO BE SEEDED ON ALL EXPOSED AREAS WITHIN SEVEN (7) DAYS AFTER FINAL GRADING. MULCH TO BE USED AS NECESSARY FOR PROTECTION UNTIL SEEDING IS ESTABLISHED.
- . AT THE TIME WHEN THE SITE PREPARATION FOR PERMANENT VEGETATIVE STABILIZATION IS GOING TO BE ACCOMPLISHED, ANY SOUL THAT WILL NOT PROVIDE A SUITABLE ENVIRONMENT TO SUPPORT ADEQUATE VEGETATIVE GROUND COVER SHALL BE REMOVED OR TREATED IN SUCH A WY THAT WILL PERMANENTLY ADJUST THE SOUL CONDITIONS AND RENDER THEM SUITABLE FOR VEGETATIVE GROUND COVER. IF THE REMOVAL OR TREATMENT OF THE SOUL WILL NOT PROVIDE SUITABLE CONDITIONS, NON-VEGETATIVE MEANS OF PERMANENT GROUND. STABILIZATION SHALL BE EMPLOYED.
- DISTURBED AREAS AND STOCKPILED MATERIALS, WHICH WILL NOT BE RE-DISTURBED WITHIN THIRTY (30) DAYS, SHALL BE STABILIZED BY USE OF MULCHING, SEEDING, GEOTEXTILE FABRIC, OR OTHER APPROVED METHODS.
- CLEANING OF FOADWAYS. CONTRACTOR SMALL KEEP ALL TRAVELED WAYS FREE OF FOREIGN GREETS BUSH AS SPILLED EATH, ROCK, AND OTHER TIENS THAT MAY FALL FROM TRANSPORTING VEHICLES. MATERIALS SPILLED BY OR DROPPED FROM THE UNDERCARRIAGE OF ANY CARRYING VEHICLE USED IN CONTRACTOR'S HAULING OPERATIONS ALONG OR ACROSS ANY PUBLIC TRAVELED MAY SHALL BE REMOVED IMMEDIATELY.

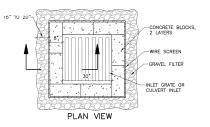


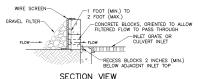

NOTES:

1. TO BE INSTALLED AT ALL INLETS WITHIN THE LIMITS OF WORK.


INLET SILT PROTECTION DETAIL NOT TO SCALE

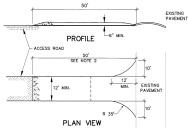

# NOTES:

- 1 STONE SIZE-LISE SUBBASE MATERIAL
- 2 LENGTH-AS REQUIRED BUT NOT LESS THAN 50'
- 3. THICKNESS-NOT LESS THAN 6"
- 4. STABILIZATION FABRIC WILL BE PLACED OVER THE ENTIRE AREA PRIOR TO PLACING OF STONE
- 5. MAINTENANCE—THE ENTRANCE SHALL BE MAINTAINED IN A CONDITION WHICH MILL PREVENT TRACKING OR FLOWING OF SEDMENT ONTO PUBLIC RIGHTS—OF—WAY. THIS MAY REQUIRE PERIODIC TOP DRESSING AS CONDITIONS DEMAND AND REPAIR AND/OR CLE
- 6. PERIODIC INSPECTION AND NEEDED MAINTENANCE SHALL BE PROVIDED AFTER EACH RAIN.


## STABILIZED CONSTRUCTION ENTRANCE DETAIL NOT TO SCALE

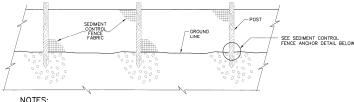

# NOTES:

- CONTRACTOR SHALL FURNISH AND INSTALL SEDIMENT CONTROL FENCE AT LOCATIONS SHOWN.
- 2. FENCE FABRIC SHALL BE FASTENED SECURELY TO FENCE POSTS WITH TIES OR STAPLES
- WHEN TWO SECTIONS OF FENCE FABRIC ADJOIN EACH OTHER THEY SHALL BE OVERLAPPED BY SIX INCHES AND FOLDED.
- MAINTENANCE SHALL BE PERFORMED AS NEEDED AND MATERIAL REMOVED WHEN "BULGES" DEVELOP IN THE FENCE.

# SEDIMENT CONTROL FENCING DETAIL NOT TO SCALE

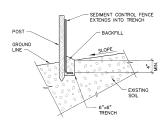

# SEDIMENT CONTROL FENCE ANCHOR DETAIL

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# S.S. STRESS PLATE (TYP.)

## NOTES:

- 18 OZ. NYLON — REINFORCED PVC FABRIC (300 PSI TEST) WITH LACING GROMMETS

TURBIDITY CURTAIN SHALL EXTEND FROM THE WATER SURFACE TO 6" OFF THE LAGOON BOTTOM AND FROM END TO END WITHOUT GAP.

CLOSED CELL SOLID PLASTIC FOAM FLOATATION (6" DIS. EQUIV.) (12 LBS. PER FT. BUOYANCY)

5/8" POLYPRO ROPE


(600 LBS. BREAKING STRENGTH)

1/4" GALVANIZED CHAIN


- SHORE AND BOTTOM ANCHORS SHALL BE SUPPLIED AS REQUIRED UPON INSTALLATION.
- 3. MAINTENANCE SHALL BE PERFORMED AS SPECIFIED AND THE CURTAIN MOVED JUST BEFORE ACCUMULATED SEDIMENT REACHES THE LOWER EDGE OF THE CURTAIN. TUDDITION OF THE CURTAIN THE PROPERTY OF THE CURTAIN THE PROPERTY OF THE CURTAIN


# TURBIDITY CURTAIN DETAIL

NOT TO SCALE

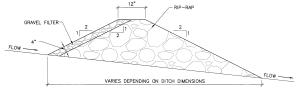

## **ELEVATION VIEW**

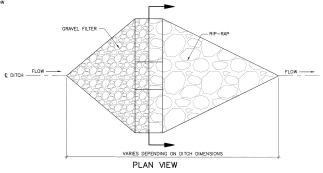

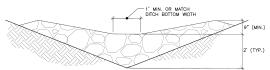

SECTION VIEW

# CHECK DAM DETAIL


NOT TO SCALE


GENERAL DETAILS II


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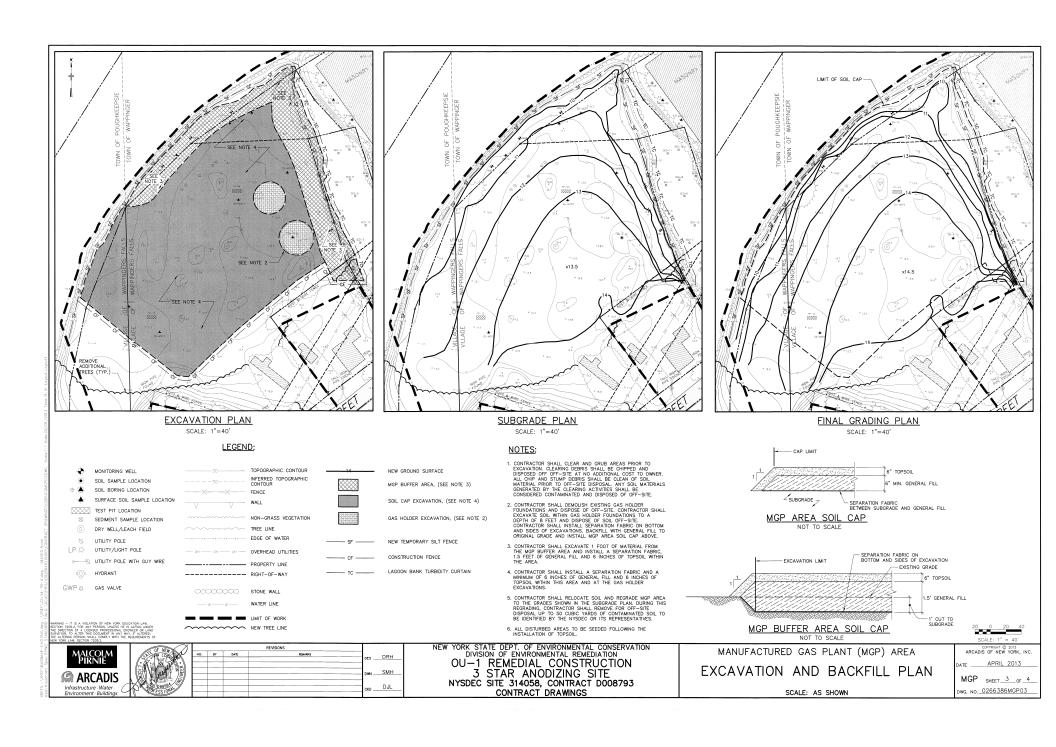
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🔎 arcadis Infrastructure · Water





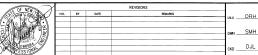


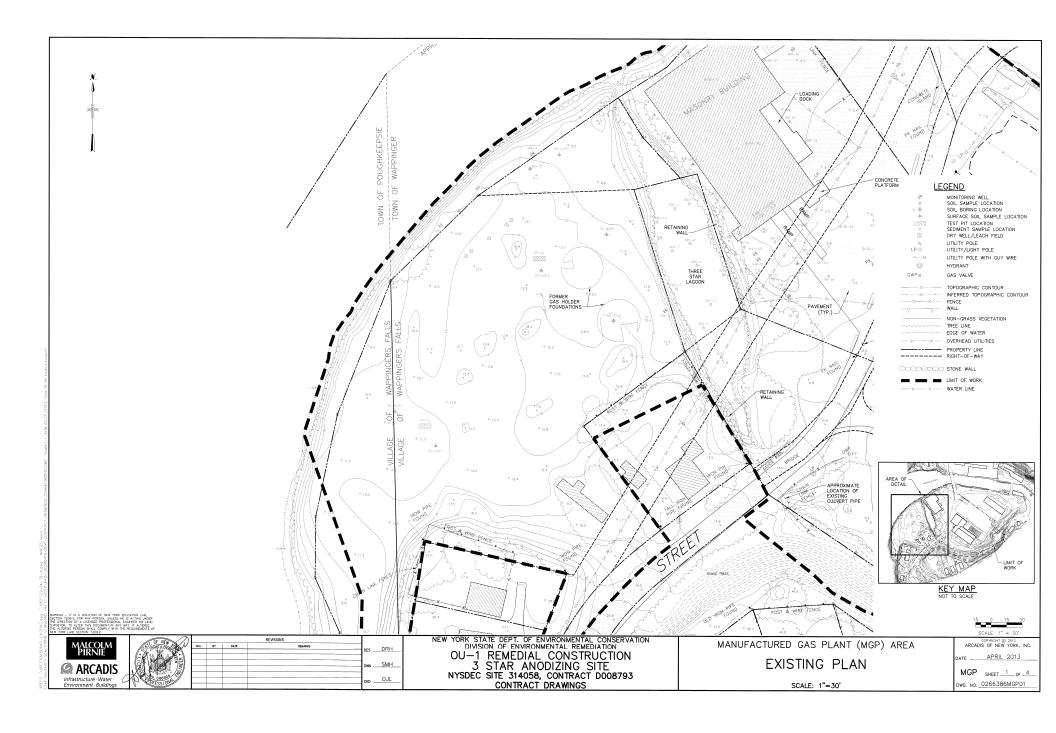

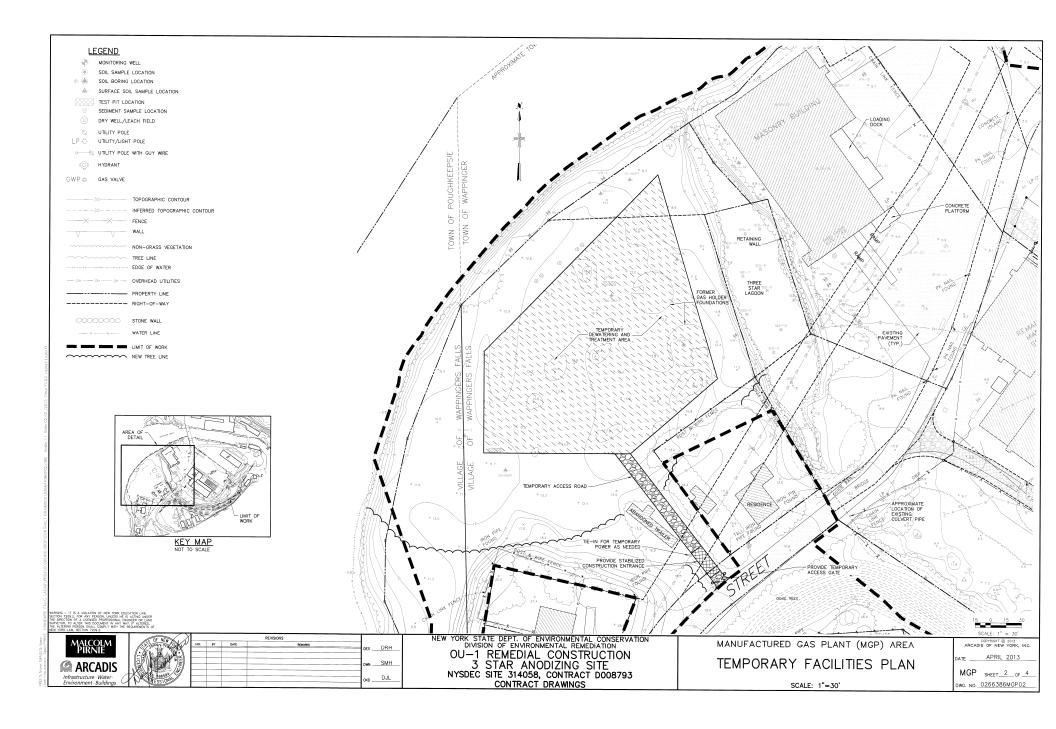


# LONGITUDINAL SECTION

NOT TO SCALE

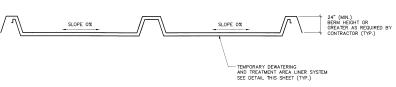


TRANSVERSE SECTION

NOT TO SCALE

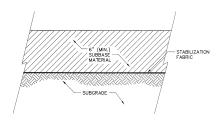

# ACCESS ROADWAY DETAIL

NOT TO SCALE

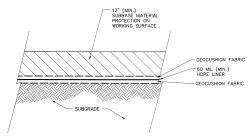


- GEOMEMBRANE LINER SHALL EXTEND UNDER ALL OF TEMPORARY DEWATERING AND TREATMENT AREA. PROVIDE PERIMETER BERMS TO MAINTAIN CONTAINMENT NECESSARY FOR OPERATIONS AND STORMWATER COLLECTION.
- 2. GEOMEMBRANE LINER SHALL BE MINIMUM 60 MIL DOUBLE-SDED TEXTURED HOPE GEOMEMBRANE OF COULT. GEOMEMBRANE SHALL BE TEXTURED HOPE STATE OF THE STATE OF THE STATE OF THE STATE NECESSARY. ALL SEAMS, PATCHES, DEFECTS, ETC. SHALL BE NON-DESTRUCTIVELY TESTED AND DOCUMENTED IN ACCORDANCE WITH THE MINIMUM STANDARDS OF 6 NIVERY PART 360 REGULATORY.

TEMPORARY DEWATERING AND TREATMENT AREA DETAIL

NOT TO SCALE

MARRING — IT IS A VIOLATION OF NEW YORK IDUCATION LAW, SECTION 7208.2, FOR ANY PERSON, LINLESS HE IS ACTING UNDER THE DIRECTION OF A LICENSED PROFESSIONAL ENGINEER OR LAND SURVEYOR, TO ALTER THIS DOCUMENT IN ANY WAY, IF ALTERED, THE ALTERING PERSON SHALL COURTY WHIT THE RECLIFICATION



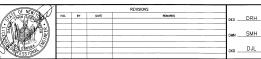

NEW YORK STATE DEPT. OF ENVIRONMENTAL CONSERVATION DIVISION OF ENVIRONMENTAL REMEDIATION OU-1 REMEDIAL CONSTRUCTION 3 STAR ANODIZING SITE NYSDEC SITE 314058, CONTRACT D008793 CONTRACT DRAWINGS

MANUFACTURED GAS PLANT (MGP) AREA

TEMPORARY FACILITIES DETAILS


NOT TO SCALE


ARCADIS OF NEW YORK, INC.

DATE \_\_\_\_\_APRIL\_2013

MGP \_\_\_SHEET\_4\_\_oF\_4\_

DWG, NO\_0266386MGP04

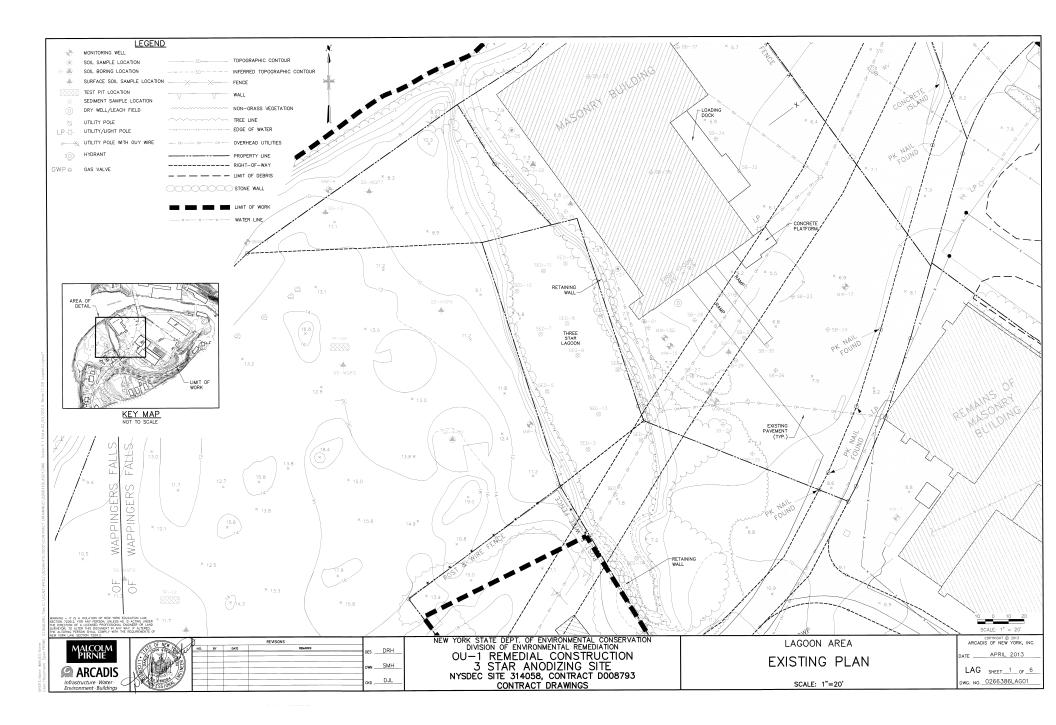

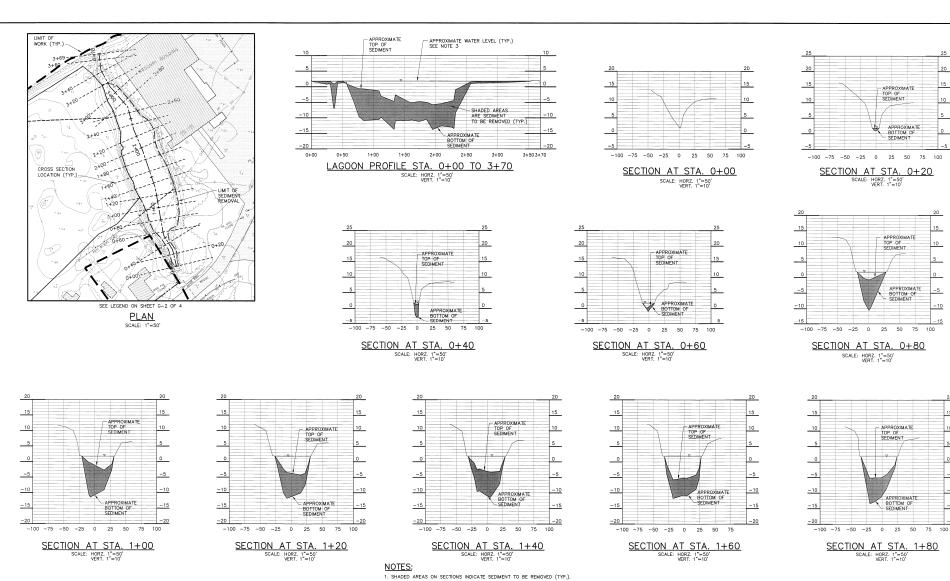

es DRH MIN \_\_\_\_SMH ARCADIS CKD DJL

CONTRACTOR SHALL NOTE THE AXTON CROSS BUILDING AND STONE RETAINING WALLS ARE IN CLOSE PROXIMITY
TO THE LAGGON. CONTRACTOR SHALL PROVIDE A WORK PLAN TO MONITOR AND SHORE THE BUILDING, STONE
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THE WATER LEVEL IN THE LAGOON FLUCTUATES WITH THE TIDE, PRECIPITATION AND OTHER NATURAL OCCURRENCES.

NEW YORK STATE DEPT. OF ENVIRONMENTAL CONSERVATION DIVISION OF ENVIRONMENTAL REMEDIATION OU—1 REMEDIAL CONSTRUCTION 3 STAR ANODIZING SITE NYSDEC SITE 314058, CONTRACT D008793 CONTRACT DRAWINGS

LAGOON AREA

LAGOON CROSS SECTIONS I

SCALE: AS SHOWN


APRIL 2013 LAG SHEET 2 OF 6 wg. No. 0266386LAG02


APPROXIMATE BOTTOM OF SEDIMENT

APPROXIMATE


- APPROXIMATE TOP OF SEDIMENT

SCALE: HORZ. 1"=50' VERT. 1"=10'

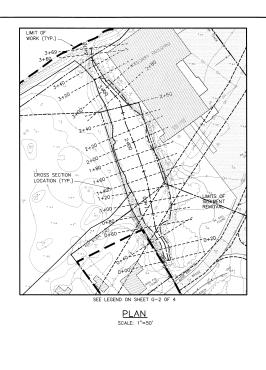


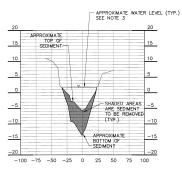


SECTION AT STA. 2+00 SCALE: HORZ. 1"=50" VERT. 1"=10"

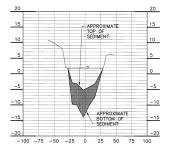


SECTION AT STA. 2+20

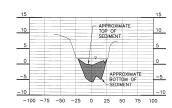


SECTION AT STA. 2+40 SCALE: HORZ. 1"=50" VERT. 1"=10"

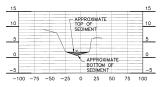


SECTION AT STA. 2+60

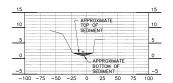

SECTION AT STA. 2+80

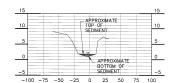


SECTION AT STA. 3+00

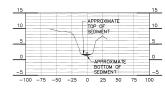


SECTION AT STA. 3+20

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VERT. 1"=10"

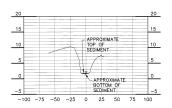


SECTION AT STA. 3+40

SCALE: HORZ. 1"=10"

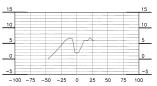

SECTION AT STA. 3+60 SCALE: HORZ. 1"=50" VERT. 1"=10"

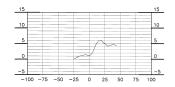

SECTION AT STA. 3+69.59

SCALE: HORZ. 1"=50"
VERT. 1"=10"

- 1. SHADED AREAS ON SECTIONS INDICATE SEDIMENT TO BE REMOVED (TYP.).
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ARCADIS OF NEW YORK, INC. APRIL 2013 LAG SHEET 3 OF 6

DWG. NO. 0266386LAG03


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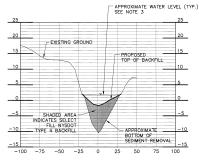
LAGOON AREA

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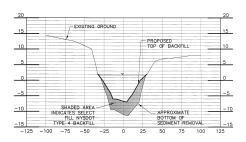
LAGOON CROSS SECTIONS II






SECTION A-A'

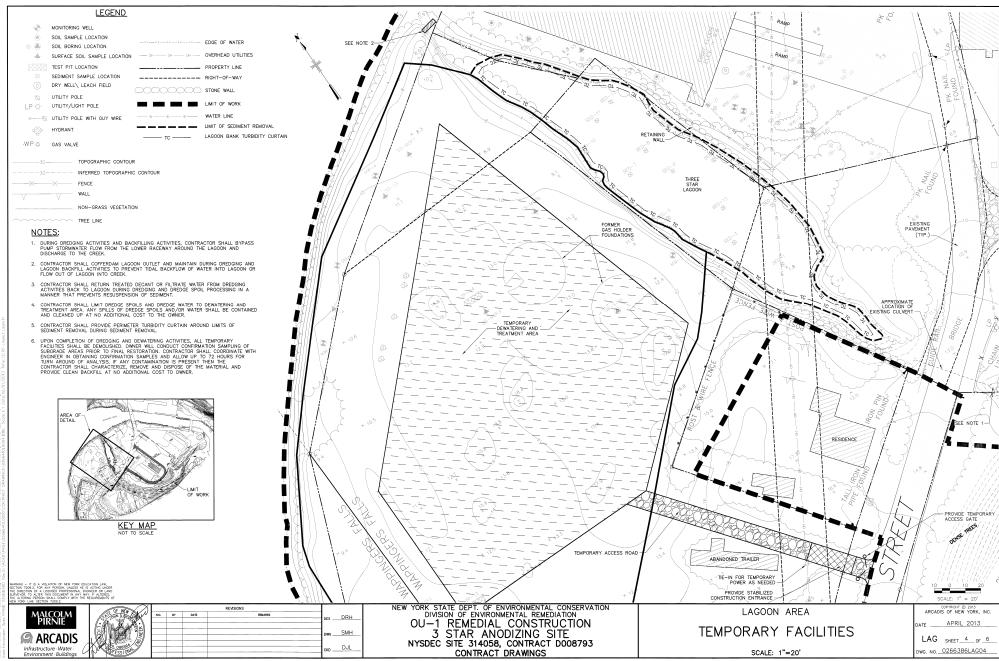
SCALE: HORZ. 1"=40'
VERT. 1"=10'



SECTION B-B'
SCALE: HORZ. 1"=40'
VERT. 1"=10'

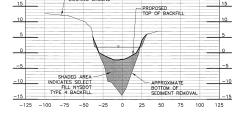

SECTION C-C'
SCALE: HORZ. 1"=40"
VERT. 1"=10"

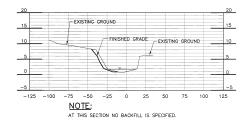

SECTION D-D'

SCALE: HORZ. 1"=40'
VERT. 1"=10'

# NOTES:


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MALCOLM PIRNIE

ARCADIS

Infrastructure Water Environment Buildings



NEW YORK STATE DEPT. OF ENVIRONMENTAL CONSERVATION
DIVISION OF ENVIRONMENTAL REMEDIATION
OU-1 REMEDIAL CONSTRUCTION
3 STAR ANODIZING SITE
NYSDEC SITE 314058, CONTRACT D008793
CONTRACT DRAWINGS

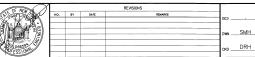LAGOON AREA

BACKFILL PLAN AND SECTIONS

SCALE: AS SHOWN


RT. SCALE: 1"=10" HORZ. SCALE: 1"=4"


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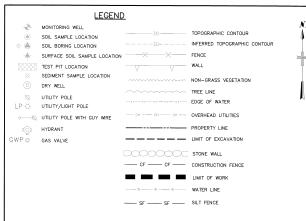
DATE APRIL 2013

LAG SHEET 5 OF 6

DWG. NO. 0266386LAG05




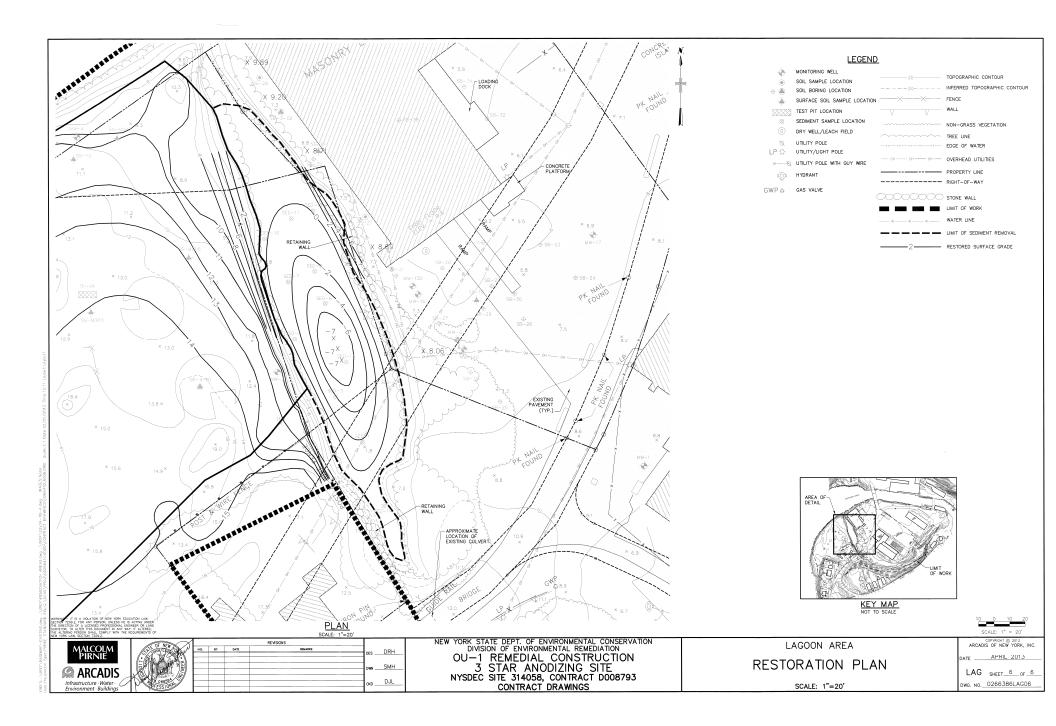

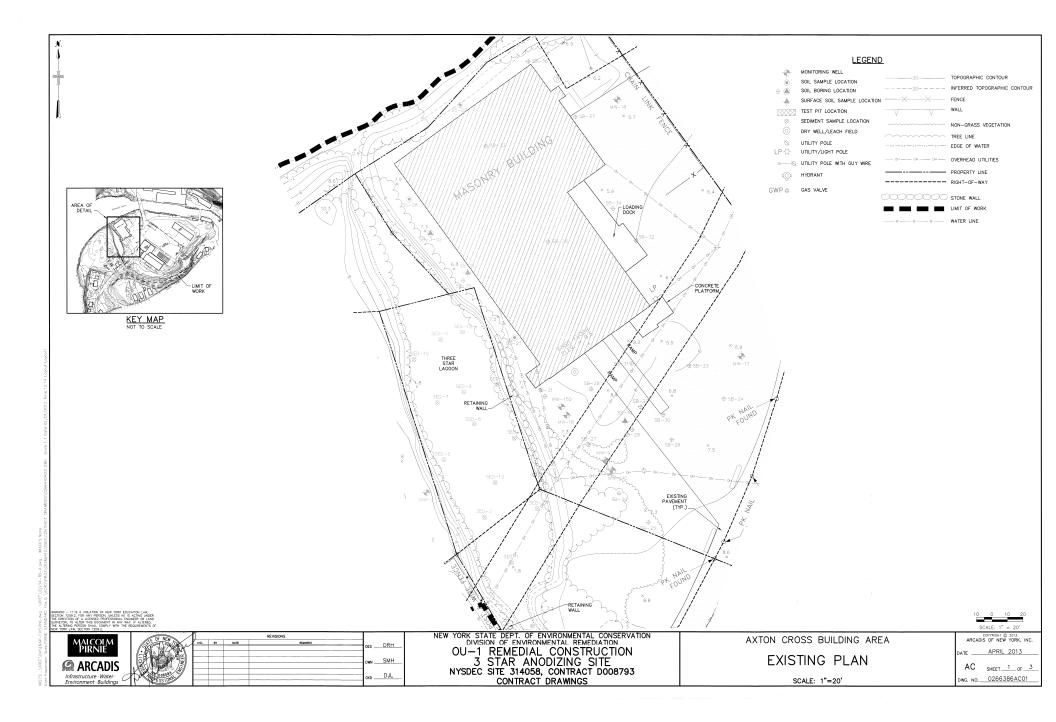

# NOTES:

- 1. EXCAVATE ASPHALT AND SOIL TO EL. 2.0 OR TO LEACH FIELD IF ENCOUNTERED.
- CONTRACTOR SHALL DEVELOP AND IMPLEMENT WORK PLAN FOR THE MONITORING AND SHORING OF THE AXTON CROSS BUILDING AS NECESSARY DURING EXCAVATION AND BACKFILL OPERATIONS.
- CONTRACTOR SHALL COORDINATE WORK AND BUILDING ACCESS IN ACCORDANCE WITH SECTION 01 11 15, SPECIAL CONSTRUCTION CONDITIONS.
- 4. CONTRACTOR SHALL PROTECT UTILITIES AND OTHER BUILT FEATURES WITHIN AND ADJACENT TO THE LIMIT OF EXCAVATION, CONTRACTOR SHALL PROVIDE TEMPORARY UTILITIES TO MAINTAIN SERVICES TO AZYTON CROSS BUILDING AT ALL TIMES.

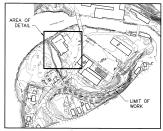

KEY MAP NOT TO SCALE



WARNING — IT IS A WOLATION OF NEW YORK EDUCATION LAW, IECTION 2209.2, FOR ANY PERSON, UNLESS HE IS ACTING UNDER HE DIRECTION OF A LICENSED PROPESSIONAL ENGINEER OR LAND SURVEYOR, TO ALTER THIS DOCUMENT IN ANY WAY, IF ALTERD, HE ALTERNO PERSON SHALL COMPLY WITH THE REQUIREMENTS OF

MALCOLM PIRNIE

ARCADIS
Infrastructure Water - Environment: Buildings

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NEW YORK STATE DEPT. OF ENVIRONMENTAL CONSERVATION DIVISION OF ENVIRONMENTAL REMEDIATION OU—1 REMEDIAL CONSTRUCTION 3 STAR ANODIZING SITE NYSDEC SITE 314058, CONTRACT D008793 CONTRACT DRAWINGS


AXTON CROSS BUILDING AREA


**EXCAVATION PLAN** 


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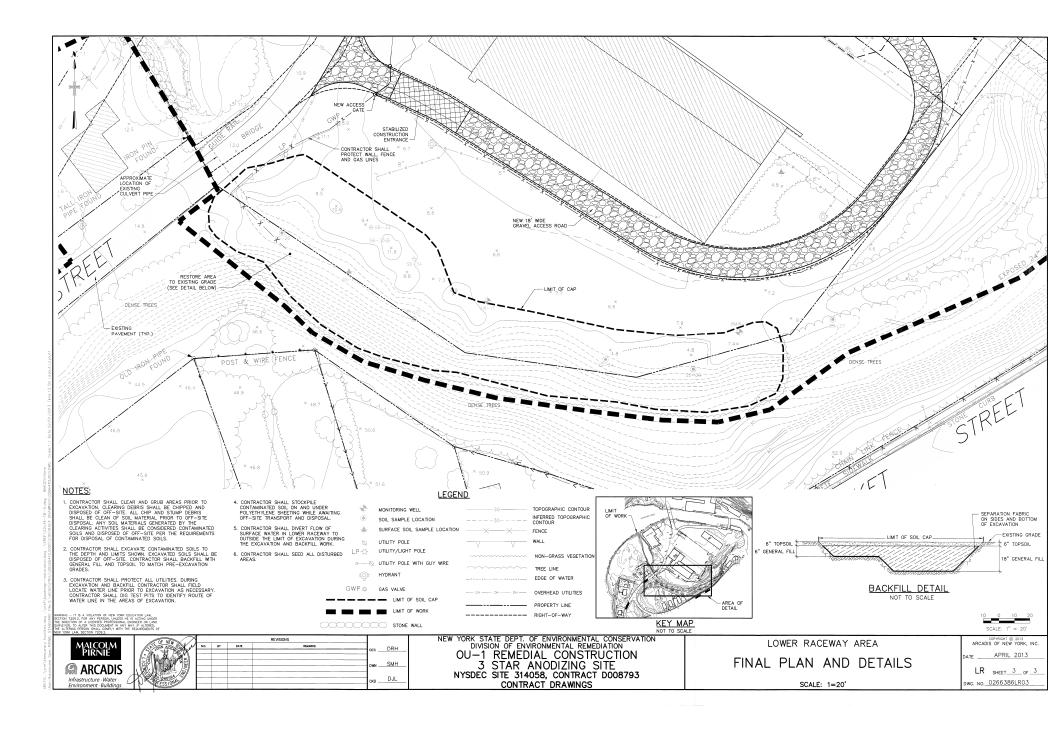
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ARCAD	COPYRIGHT @ 2013 IS OF NEW YORK, INC.
DATE	APRIL 2013
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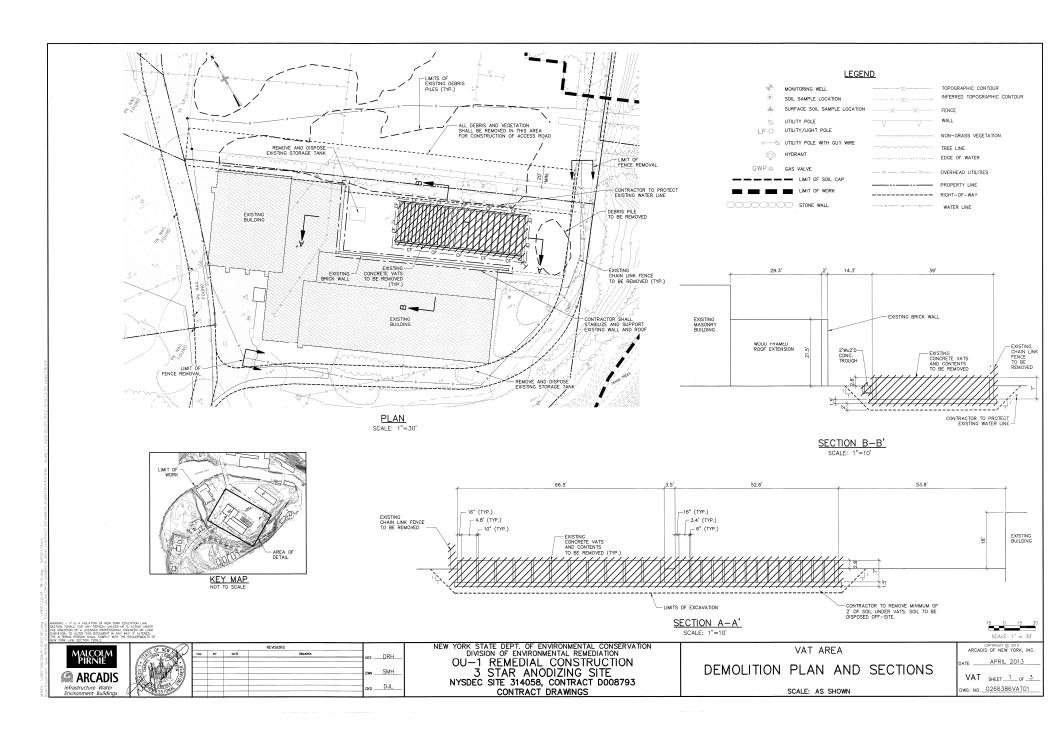
S.None IMAGES:None Hausmann Seed PIRNIF STAND






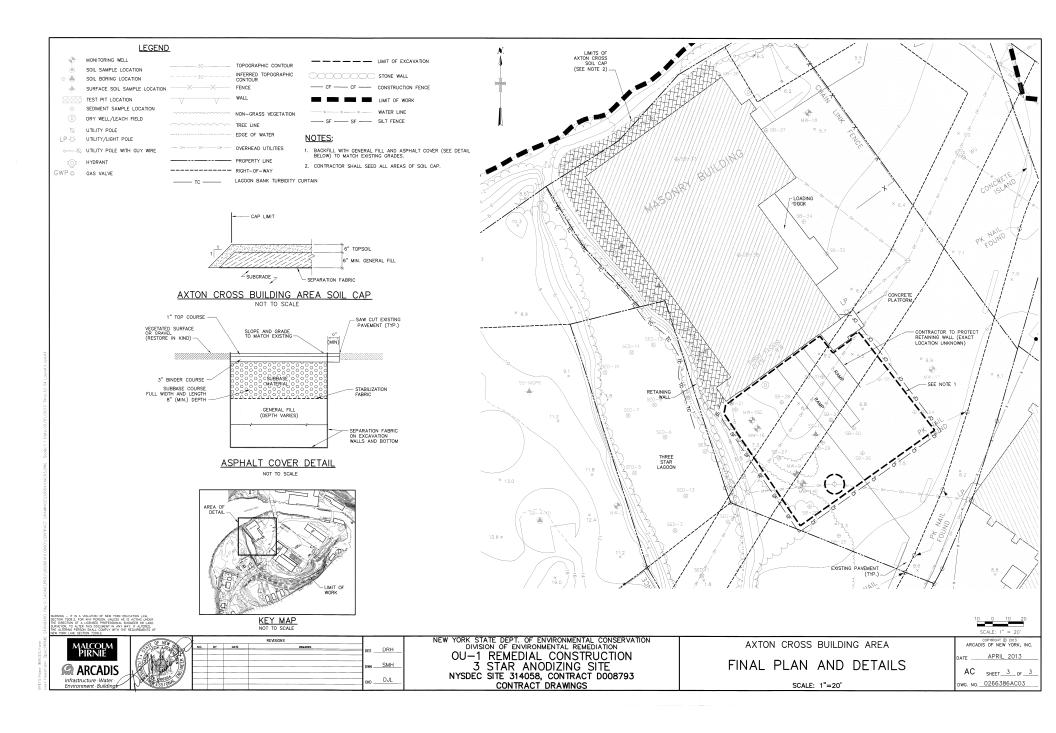

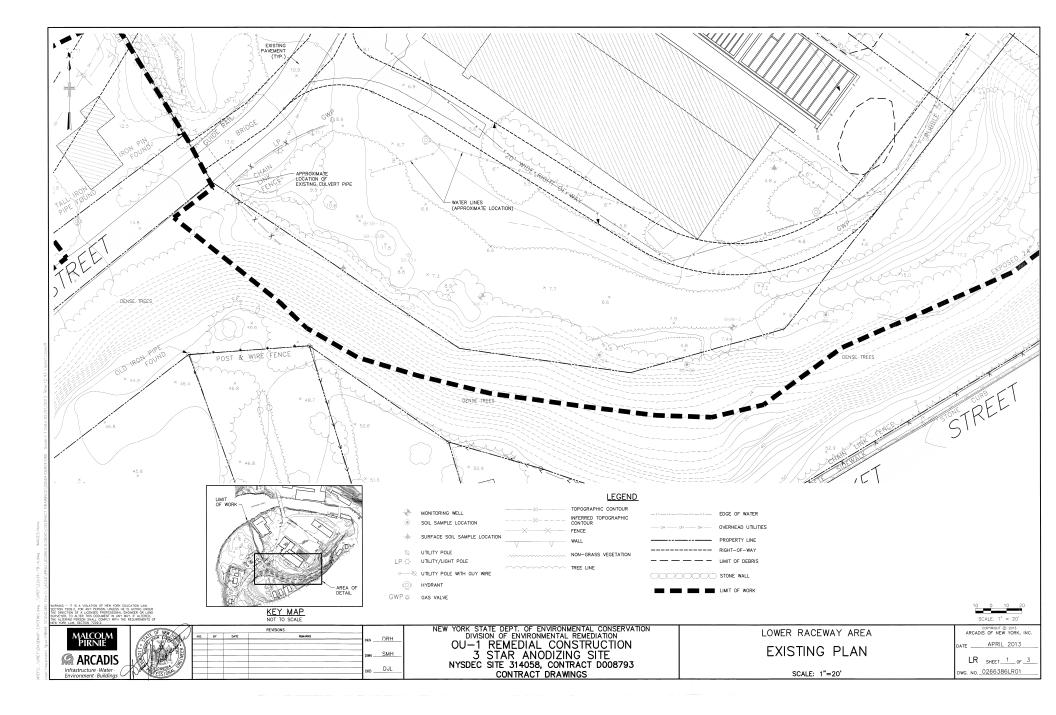

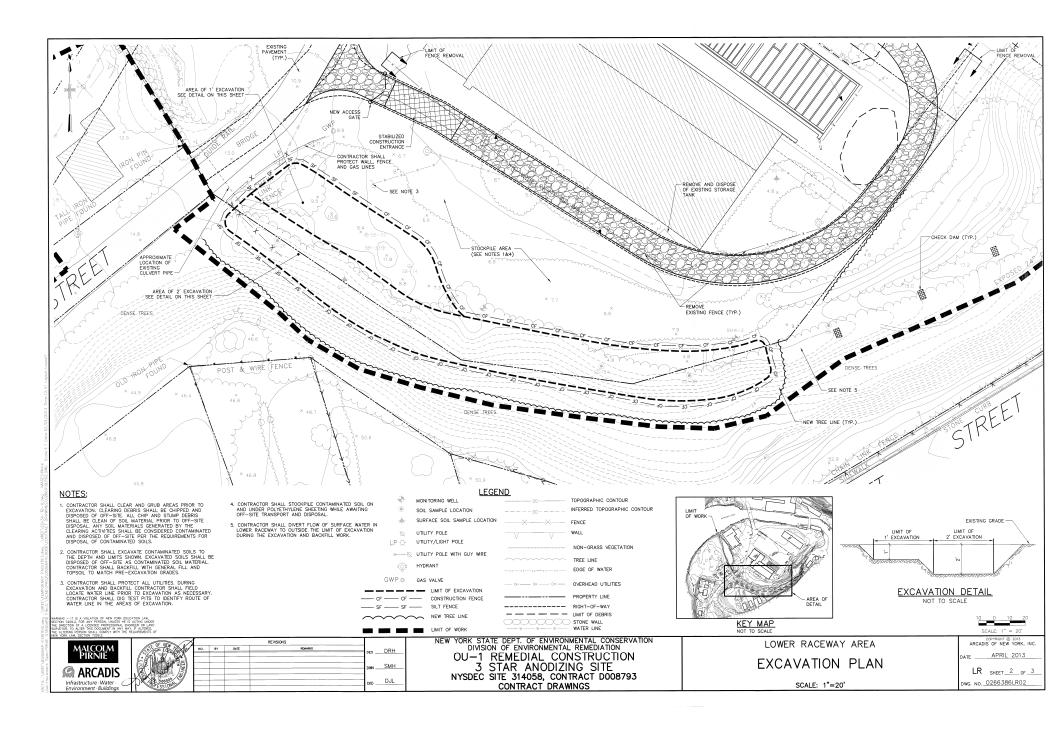

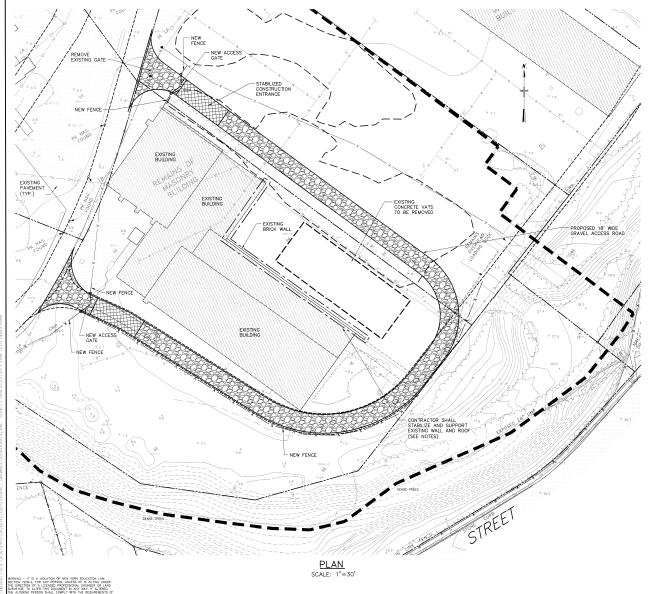

# **LEGEND**

<b>⊕</b> ⊚	MONITORING WELL SOIL SAMPLE LOCATION	30	TOPOGRAPHIC CONTOUR INFERRED TOPOGRAPHIC CONTOUR
-4-	SURFACE SOIL SAMPLE LOCATION	<del></del> ×	FENCE
Ø	UTILITY POLE	$\neg \lor \neg \lor \neg$	WALL
LP-Ö-	UTILITY/LIGHT POLE		NON-GRASS VEGETATION
Q0	UTILITY POLE WITH GUY WIRE	~~~~~	TREE LINE
•	HYDRANT		EDGE OF WATER
GWP ©	GAS VALVE	— он — он — он —	OVERHEAD UTILITIES
	LIMIT OF EXCAVATION		PROPERTY LINE
	LIMIT OF WORK		RIGHT-OF-WAY
0000000	STONE WALL		WATER LINE

# NOTES:

- CONTRACTOR SHALL SAFEGUARD EXISTING BUILDING STRUCTURE AND PERSONNEL FROM DAMAGE DURING VAT EXCAVATION AND BACKFILL ACTIVITIES.
- CNITRACTIR MAY 19T TO CAFEGUAD EXISTING BUILDING STRUCTURE FROM DAMAGE OR SELECTIVELY DEMOUSH STRUCTURE TO ALLOW FOR ACCESS TO VAIS WITHOUT COMPROMISION THE BUILDING FOUNDATION. IN THE EVENT STRUCTURE TO ALLOW FOR ACCESS TO VAIS STRUCTURE BUILDING FOUNDATION. AND THE EVENT DEBRIS (I.E. CLEAN AND UNCONTAMINATED BRICK, BLOCK, GLOSS, ROCK, SOIL AND CONCRETE FROM OTHER CAD DEBRIS (I.E. WOOD, ROOFING, INSULATION, MISCELLANEOUS DEBRIS IN STRUCTURE) FOR FUTURE DISPOSAL BY OTHERS.



KEY MAP NOT TO SCALE

15 0 15 30 SCALE: 1" = 30"

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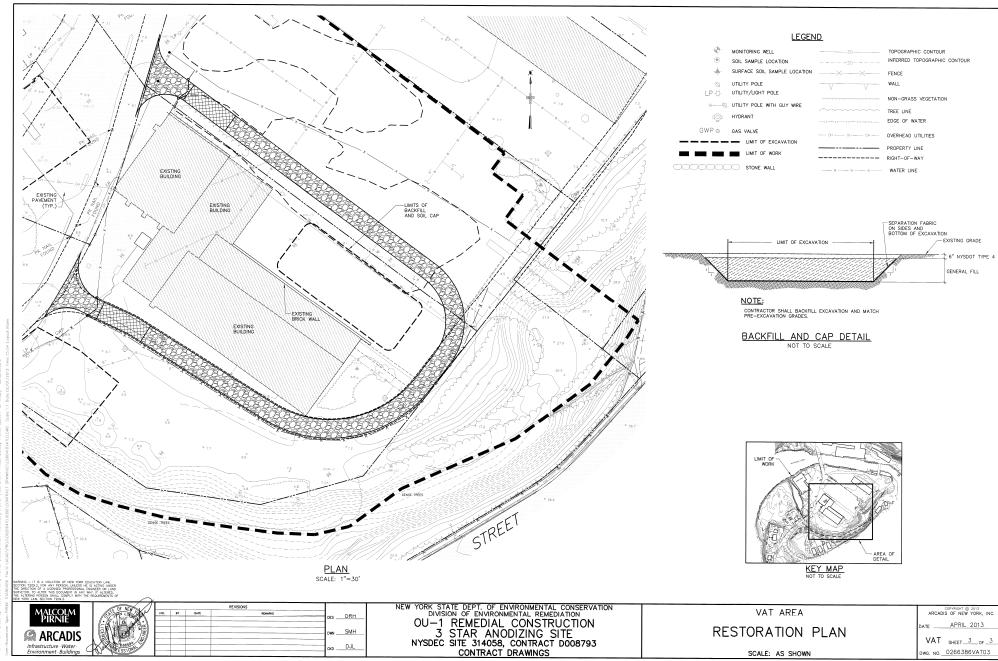
NEW YORK STATE DEPT. OF ENVIRONMENTAL CONSERVATION DIVISION OF ENVIRONMENTAL REMEDIATION OU—1 REMEDIAL CONSTRUCTION 3 STAR ANODIZING SITE NYSDEC SITE 314058, CONTRACT D008793 CONTRACT DRAWINGS

VAT AREA
TEMPORARY FACILITIES PLAN
AND DETAILS
SCALE: AS SHOWN

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VAT <sub>SHEET\_2 OF\_3</sub> DWG, NO,\_0266386VAT02



DWG. NO. 0266386VAT03

SCALE: AS SHOWN