

# NEW YORK STATE DEPARTMENT OF ENVIRONMENTAL CONSERVATION

## Division of Environmental Permits, Region 8

6274 East Avon-Lima Road, Avon, NY 14414-9516

P: (585) 226-5400 | F: (585) 226-2830

[www.dec.ny.gov](http://www.dec.ny.gov)

### **IMPORTANT NOTICE TO ALL PERMITTEES**

The permit you requested is enclosed. **Please read it carefully and note the conditions that are included in it.** The permit is valid for only those activities expressly authorized therein. Work beyond the scope of the permit and the approved project plans may be considered a violation of the law and be subject to appropriate enforcement action. Granting of this permit does not relieve the permittee of the responsibility of obtaining any other permission, consent, or approval from any other Federal, State or local government which may be required. Please be sure to check with the local municipality regarding the potential need for local approval.

**PLEASE NOTE:** You must submit a Notice of Intent to Commence Work (attached) prior to starting work and similar notification must also be made upon completion of project as noted in the permit conditions. If a Permit Notice Sign is enclosed, you must post it at the work site with appropriate weather protection, as well as a copy of the permit per General Condition #1.

Please note the expiration date of the permit. If you need additional time to complete your project, you must submit your request for permit renewal, in writing, prior to expiration of the permit (minimum of 30 days) and submitted to the Regional Permit Administrator at the above address. Provide an explanation of why additional time is needed and how much additional time you are requesting. Please refer to the general conditions listed in the permit for specific instructions. For SPDES, solid Waste and Hazardous Waste Permits, renewal applications must be made at least 180 days prior to the expiration date.

The DEC permit number & Program ID number noted on page 1 under "Permit Authorization" of the permit are important and should be retained for your records. These numbers should be referenced on all correspondence related to the permit, and on any future applications for permits associated with this facility/project area.

For many projects involving work in and around streams, lakes and wetlands the US Army Corps of Engineers (USACE) may have regulatory authority in addition to this Department. If you have not already done so, you should contact their Buffalo District Regulatory Branch office at 716-879-4330 to obtain any required federal authorizations prior to commencing work. Also as a reminder, be sure to verify whether any local approvals are required for the project.

If you have any questions on the extent of the work authorized or your obligations under the permit, please feel free to contact me at 585-226-5382.

Sincerely,



Frances Knickmeyer  
Environmental Analyst



Department of  
Environmental  
Conservation



## PERMIT

### Under the Environmental Conservation Law (ECL)

#### Permittee and Facility Information

**Permit Issued To:**

NYS Dept of Environmental Conservation

625 BROADWAY  
ALBANY, NY 12233

**Facility:**

GENESEE RIVER REMEDIAL RIVER  
DREDGING  
GENESEE RIVER - N OF ST RTE 104  
ROCHESTER, NY

**Facility Location:** in ROCHESTER in MONROE COUNTY

**Facility Principal Reference Point:** NYTM-E: 287.604 NYTM-N: 4788.707  
Latitude: 43°13'16.6" Longitude: 77°36'54.6"

**Project Location:** Genesee River, between Turning Point Park & King's Landing WWTP

**Authorized Activity:** Remediate portions of the Lower Genesee River and its adjacent wetlands by conducting environmental dredging and excavation to remove sediments contaminated from the historic releases of silver from Kodak's former operations at the Eastman Business Park located adjacent to the Lower Genesee River. The site includes approximately 2.5 miles of the Lower Genesee River and adjoining wetland and floodplain.

In-river dredging to a depth of 2.5 feet will occur at two separate locations totaling 2.9 acres. The in-river dredge area includes regulated Adjacent Area for NYS Freshwater Wetland RH-8.

Approximately 14,500 CY will be removed at in-river locations. An isolation cap will be placed over dredged areas of the riverbed to minimize changes in surface elevation. Wetland excavation to a depth of 2.5 feet over 2.2 acres (9,400 CY) will occur in NYS Regulated Freshwater Wetland RH-21. To minimize changes in surface elevation, backfill will be placed in excavated areas of the wetlands.

**As specified in Natural Resources Special Condition 5, the following in-water work restrictive periods apply:**

- For the protection of warm/cool water species, **dredging and fillings prohibited from April 15 through June 30** in the main river channel (AOC-1 and AOC-2).
- For the protection of migratory Lake Ontario salmonoid species and hatchery raised lake sturgeon, **in-river work (dredging and filling) is prohibited from October 1 through November 30.**

**MODIFICATION 1:** Revisions to the design of Wetland C, including deeper access channels to facilitate dredge access and to support variable finished topography (Attachment A). **The channels will consist of variable edges.** During 2021, the in-river work restrictive period specified in **Natural Resources Special Condition 5.b. is October 31 through November 30.**

**REISSUE 1:** Extend the permit expiration date to allow replanting in the Lower Genesee River wetland.



## Permit Authorizations

### Water Quality Certification - Under Section 401 - Clean Water Act

Permit ID 8-2614-00963/00002

Reissuance

Effective Date: 1/12/2024

Expiration Date: 12/31/2027

## NYSDEC Approval

By acceptance of this permit, the permittee agrees that the permit is contingent upon strict compliance with the ECL, all applicable regulations, and all conditions included as part of this permit.

Permit Administrator: ROBERT B CALL, Deputy Regional Permit Administrator

Address: NYSDEC Region 8 Headquarters  
6274 E Avon-Lima Rd  
Avon, NY 14414

Authorized Signature: \_\_\_\_\_ Date 1/12/2024

## Permit Components

NATURAL RESOURCE PERMIT CONDITIONS

WATER QUALITY CERTIFICATION SPECIFIC CONDITION

GENERAL CONDITIONS, APPLY TO ALL AUTHORIZED PERMITS

NOTIFICATION OF OTHER PERMITTEE OBLIGATIONS

### NATURAL RESOURCE PERMIT CONDITIONS - Apply to the Following Permits: WATER QUALITY CERTIFICATION

**1. Conformance With Plans** All activities authorized by this permit must be in strict conformance with the approved plans submitted by the applicant or applicant's agent as part of the permit application. Such approved plans were prepared by Parsons, contained within Attachment H of the NYSDEC permit application package, as cited in Natural Resources Special Condition 2.

**2. Conformance with Plans - Addenda** In addition to plans referenced in the Condition titled "Conformance with Plans," the activities authorized by this permit must be in strict conformance with the following approved plans and/or submissions made as part of the permit application:



- a. Plans prepared by Parsons, titled “Lower Genesee River Corrective Measures Remedial Construction”, drawing numbers 448923-G-001, 448923-G-002, 448923-C-001 through 448923-C-008, 448923-C-010, 448923-C-011, 448923-C-013, 448923-C-014, 448923-C-017, 448923-C-019, and 448923-C-020 dated June 25, 2020, last revised October 8, 2020, received by NYSDEC October 19, 2020.
- b. Plans prepared by Parsons, titled “Lower Genesee River CMS, Section XI, Supplemental Specs”, sections “02 21 00 Surveys”, “02 22 00 Pre- and Post-Condition Surveys”, “02 51 00 Decon Procedures”, and “31 11 00 Clearing & Grubbing”, dated June 23, 2020, received by NYSDEC October 19, 2020.
- c. Plans prepared by Parsons, titled “Lower Genesee River CMS, Section XI, Supplemental Specs”, section “02 72 00 Construction Water Management”, dated June 24, 2020, received by NYSDEC October 19, 2020.
- d. Plans prepared by Parsons, titled “Lower Genesee River CMS, Section XI, Supplemental Specs”, sections “02 81 00 Off-Site Transportation & Disposal”, “31 25 00 Erosion & Sediment Control”, “32 72 00 Wetland Restoration”, “35 20 23 Dredging”, “35 20 30 Dredge Material Management & Processing”, “35 20 50 Backfilling and Capping”, and “35 80 00 Turbidity Controls and Monitoring”, dated June 23, 2020, last revised August 13, 2020, received by NYSDEC October 19, 2020.
- e. Plans prepared by Parsons, titled “Lower Genesee River CMS, Section XI, Supplemental Specs”, section “01 74 19 Waste Removal, Handling and Storage”, dated June 23, 2020, last revised October 5, 2020, received by NYSDEC October 19, 2020.
- f. Plans prepared by Parsons, titled “Lower Genesee River CMS, Section XI, Supplemental Specs”, section “35 00 00 Waterway & Marine Construction”, dated June 23, 2020, last revised July 29, 2020, received by NYSDEC October 19, 2020.
- g. Plans prepared by Parsons, titled “Lower Genesee River CMS, Section XI, Supplemental Specs”, section “01 11 13 Summary of Work”, dated June 23, 2020, last revised October 8, 2020, received by NYSDEC October 19, 2020.
- h. Plans prepared by Parsons, titled “Lower Genesee River Corrective Measures Remedial Construction”, drawing numbers 448923-C-009, 448923-C-012, 448923-C-015, and 448923-C-018, dated November 24, 2020, last revised May 14, 2021, received by NYSDEC May 14, 2021 (Attachment A).
- i. Plans prepared by Parsons, titled “Lower Genesee River Corrective Measures Remedial Construction”, drawing number 448923-C-016, dated November 24, 2020, last revised April 30, 2021, received by NYSDEC May 14, 2021 (Attachment A).



**3. Notice of Intent to Commence Work** The permittee shall submit a Notice of Intent to Commence Work to the Region 8 Division of Environmental Permits, Attention: Frances Knickmeyer (frances.knickmeyer@dec.ny.gov) at least 48 hours in advance of the time of commencement and shall also notify them promptly in writing of the completion of work.

**4. Post Permit Sign** The permit sign enclosed with this permit shall be posted in a conspicuous location on the worksite and adequately protected from the weather.

**5. In-Water Work Restrictive Periods**

- a. For the protection of warm/cool water species, dredging and filling is prohibited from April 15 through June 30 in the main river channel (AOC-1 and AOC-2).
- b. For the protection of migratory Lake Ontario salmonoid species and hatchery raised lake sturgeon, in-river work (dredging and filling) is prohibited from October 1 through November 30.
  - i. For 2021, in-river work is prohibited from October 31 through November 30.
- c. In-river work related to site mobilization is permitted between April 15 and June 30; this includes the installation of temporary shoreline support features and mooring points.
- d. Work within Wetland C will be permitted from June 1 through April 14. This includes clearing and wetland soil removal. Removed soil may be transported by barge to the site staging area.

**6. Best Management Practices** Best management practices will be employed and maintained for the duration of the project to prevent the loss of construction materials, debris and sediment from entering the wetlands or waterways. Such practices may include, but are not limited to construction fencing, staked hay bales, silt fencing, and turbidity curtains.

**7. Seed and Mulch Disturbed Areas** All areas of soil disturbance resulting from this project shall be stabilized immediately following project completion or prior to permit expiration, whichever comes first. The approved methodologies are as follows:

- a. Stabilization of the entire disturbed area with appropriate vegetation (grasses, etc.);
- b. Stabilized as per specifications identified on approved plans;
- c. Temporarily stabilized with straw or hay mulch or jute matting or other similar natural fiber matting within 7 days of final grading.

Temporary stabilization shall be maintained until a mature vegetative cover is established to the Department's satisfaction.

**8. Clean Fill Material Only** Fill material must consist only of clean inorganic sand, gravel, stone, or soil. No other materials are to be used unless specifically authorized by this permit.



**9. Dredged Material Dewatering and Disposal** Dredged and excavated material must be dewatered on-site in floating scows or onshore in the sediment loading and staging area within a delineated material handling area. Dewatered material must be disposed of at an offsite landfill.

**10. Minimize Adverse Impacts to Wetlands, Wildlife, Water** All work must be performed in a manner which minimizes adverse impacts to wetlands, wildlife, water quality and natural resources.

**11. No Interference with Navigation** There shall be no unreasonable interference with navigation by the work herein authorized.

**12. Precautions Against Contamination of Waters** All necessary precautions shall be taken to preclude contamination of any wetland or waterway by suspended solids, sediments, fuels, solvents, lubricants, epoxy coatings, paints, concrete, leachate or any other environmentally deleterious materials associated with the project.

**13. Prior Approval of Changes** If the Permittee desires to make any changes in construction techniques, species to be planted, the site plan, any mitigation plan, scheduling or staging of construction, or any other aspect of this project, the Permittee shall submit a written request to the Regional Permit Administrator to make such proposed changes and shall not make such changes unless authorized in writing by the Department.

**14. Failure to Meet Permit Conditions** Failure of the permittee to meet all the conditions of this permit is a violation of this permit and grounds for an order to immediately cease the permitted activity at the project site.

### **WATER QUALITY CERTIFICATION SPECIFIC CONDITIONS**

**1. Water Quality Certification** The authorized project, as conditioned pursuant to the Certificate, complies with Section 301, 302, 303, 306, and 307 of the Federal Water Pollution Control Act, as amended and as implemented by the limitations, standards, and criteria of state statutory and regulatory requirements set forth in 6 NYCRR Section 608.9(a). The authorized project, as conditioned, will also comply with applicable New York State water quality standards, including but not limited to effluent limitations, best usages and thermal discharge criteria, as applicable, as set forth in 6 NYCRR Parts 701, 702, 703, and 704.

### **GENERAL CONDITIONS - Apply to ALL Authorized Permits:**

**1. Facility Inspection by The Department** The permitted site or facility, including relevant records, is subject to inspection at reasonable hours and intervals by an authorized representative of the Department of Environmental Conservation (the Department) to determine whether the permittee is complying with this permit and the ECL. Such representative may order the work suspended pursuant to ECL 71- 0301 and SAPA 401(3).



The permittee shall provide a person to accompany the Department's representative during an inspection to the permit area when requested by the Department.

A copy of this permit, including all referenced maps, drawings and special conditions, must be available for inspection by the Department at all times at the project site or facility. Failure to produce a copy of the permit upon request by a Department representative is a violation of this permit.

**2. Relationship of this Permit to Other Department Orders and Determinations** Unless expressly provided for by the Department, issuance of this permit does not modify, supersede or rescind any order or determination previously issued by the Department or any of the terms, conditions or requirements contained in such order or determination.

**3. Applications For Permit Renewals, Modifications or Transfers** The permittee must submit a separate written application to the Department for permit renewal, modification or transfer of this permit. Such application must include any forms or supplemental information the Department requires. Any renewal, modification or transfer granted by the Department must be in writing. Submission of applications for permit renewal, modification or transfer are to be submitted to:

Regional Permit Administrator  
NYSDEC Region 8 Headquarters  
6274 E Avon-Lima Rd  
Avon, NY 14414

**4. Submission of Renewal Application** The permittee must submit a renewal application at least 30 days before permit expiration for the following permit authorizations: Water Quality Certification.

**5. Permit Modifications, Suspensions and Revocations by the Department** The Department reserves the right to exercise all available authority to modify, suspend or revoke this permit. The grounds for modification, suspension or revocation include:

- a. materially false or inaccurate statements in the permit application or supporting papers;
- b. failure by the permittee to comply with any terms or conditions of the permit;
- c. exceeding the scope of the project as described in the permit application;
- d. newly discovered material information or a material change in environmental conditions, relevant technology or applicable law or regulations since the issuance of the existing permit;
- e. noncompliance with previously issued permit conditions, orders of the commissioner, any provisions of the Environmental Conservation Law or regulations of the Department related to the permitted activity.

**6. Permit Transfer** Permits are transferrable unless specifically prohibited by statute, regulation or another permit condition. Applications for permit transfer should be submitted prior to actual transfer of ownership.



## NOTIFICATION OF OTHER PERMITTEE OBLIGATIONS

### **Item A: Permittee Accepts Legal Responsibility and Agrees to Indemnification**

The permittee, excepting state or federal agencies, expressly agrees to indemnify and hold harmless the Department of Environmental Conservation of the State of New York, its representatives, employees, and agents ("DEC") for all claims, suits, actions, and damages, to the extent attributable to the permittee's acts or omissions in connection with the permittee's undertaking of activities in connection with, or operation and maintenance of, the facility or facilities authorized by the permit whether in compliance or not in compliance with the terms and conditions of the permit. This indemnification does not extend to any claims, suits, actions, or damages to the extent attributable to DEC's own negligent or intentional acts or omissions, or to any claims, suits, or actions naming the DEC and arising under Article 78 of the New York Civil Practice Laws and Rules or any citizen suit or civil rights provision under federal or state laws.

### **Item B: Permittee's Contractors to Comply with Permit**

The permittee is responsible for informing its independent contractors, employees, agents and assigns of their responsibility to comply with this permit, including all special conditions while acting as the permittee's agent with respect to the permitted activities, and such persons shall be subject to the same sanctions for violations of the Environmental Conservation Law as those prescribed for the permittee.


### **Item C: Permittee Responsible for Obtaining Other Required Permits**


The permittee is responsible for obtaining any other permits, approvals, lands, easements and rights-of-way that may be required to carry out the activities that are authorized by this permit.

### **Item D: No Right to Trespass or Interfere with Riparian Rights**


This permit does not convey to the permittee any right to trespass upon the lands or interfere with the riparian rights of others in order to perform the permitted work nor does it authorize the impairment of any rights, title, or interest in real or personal property held or vested in a person not a party to the permit.



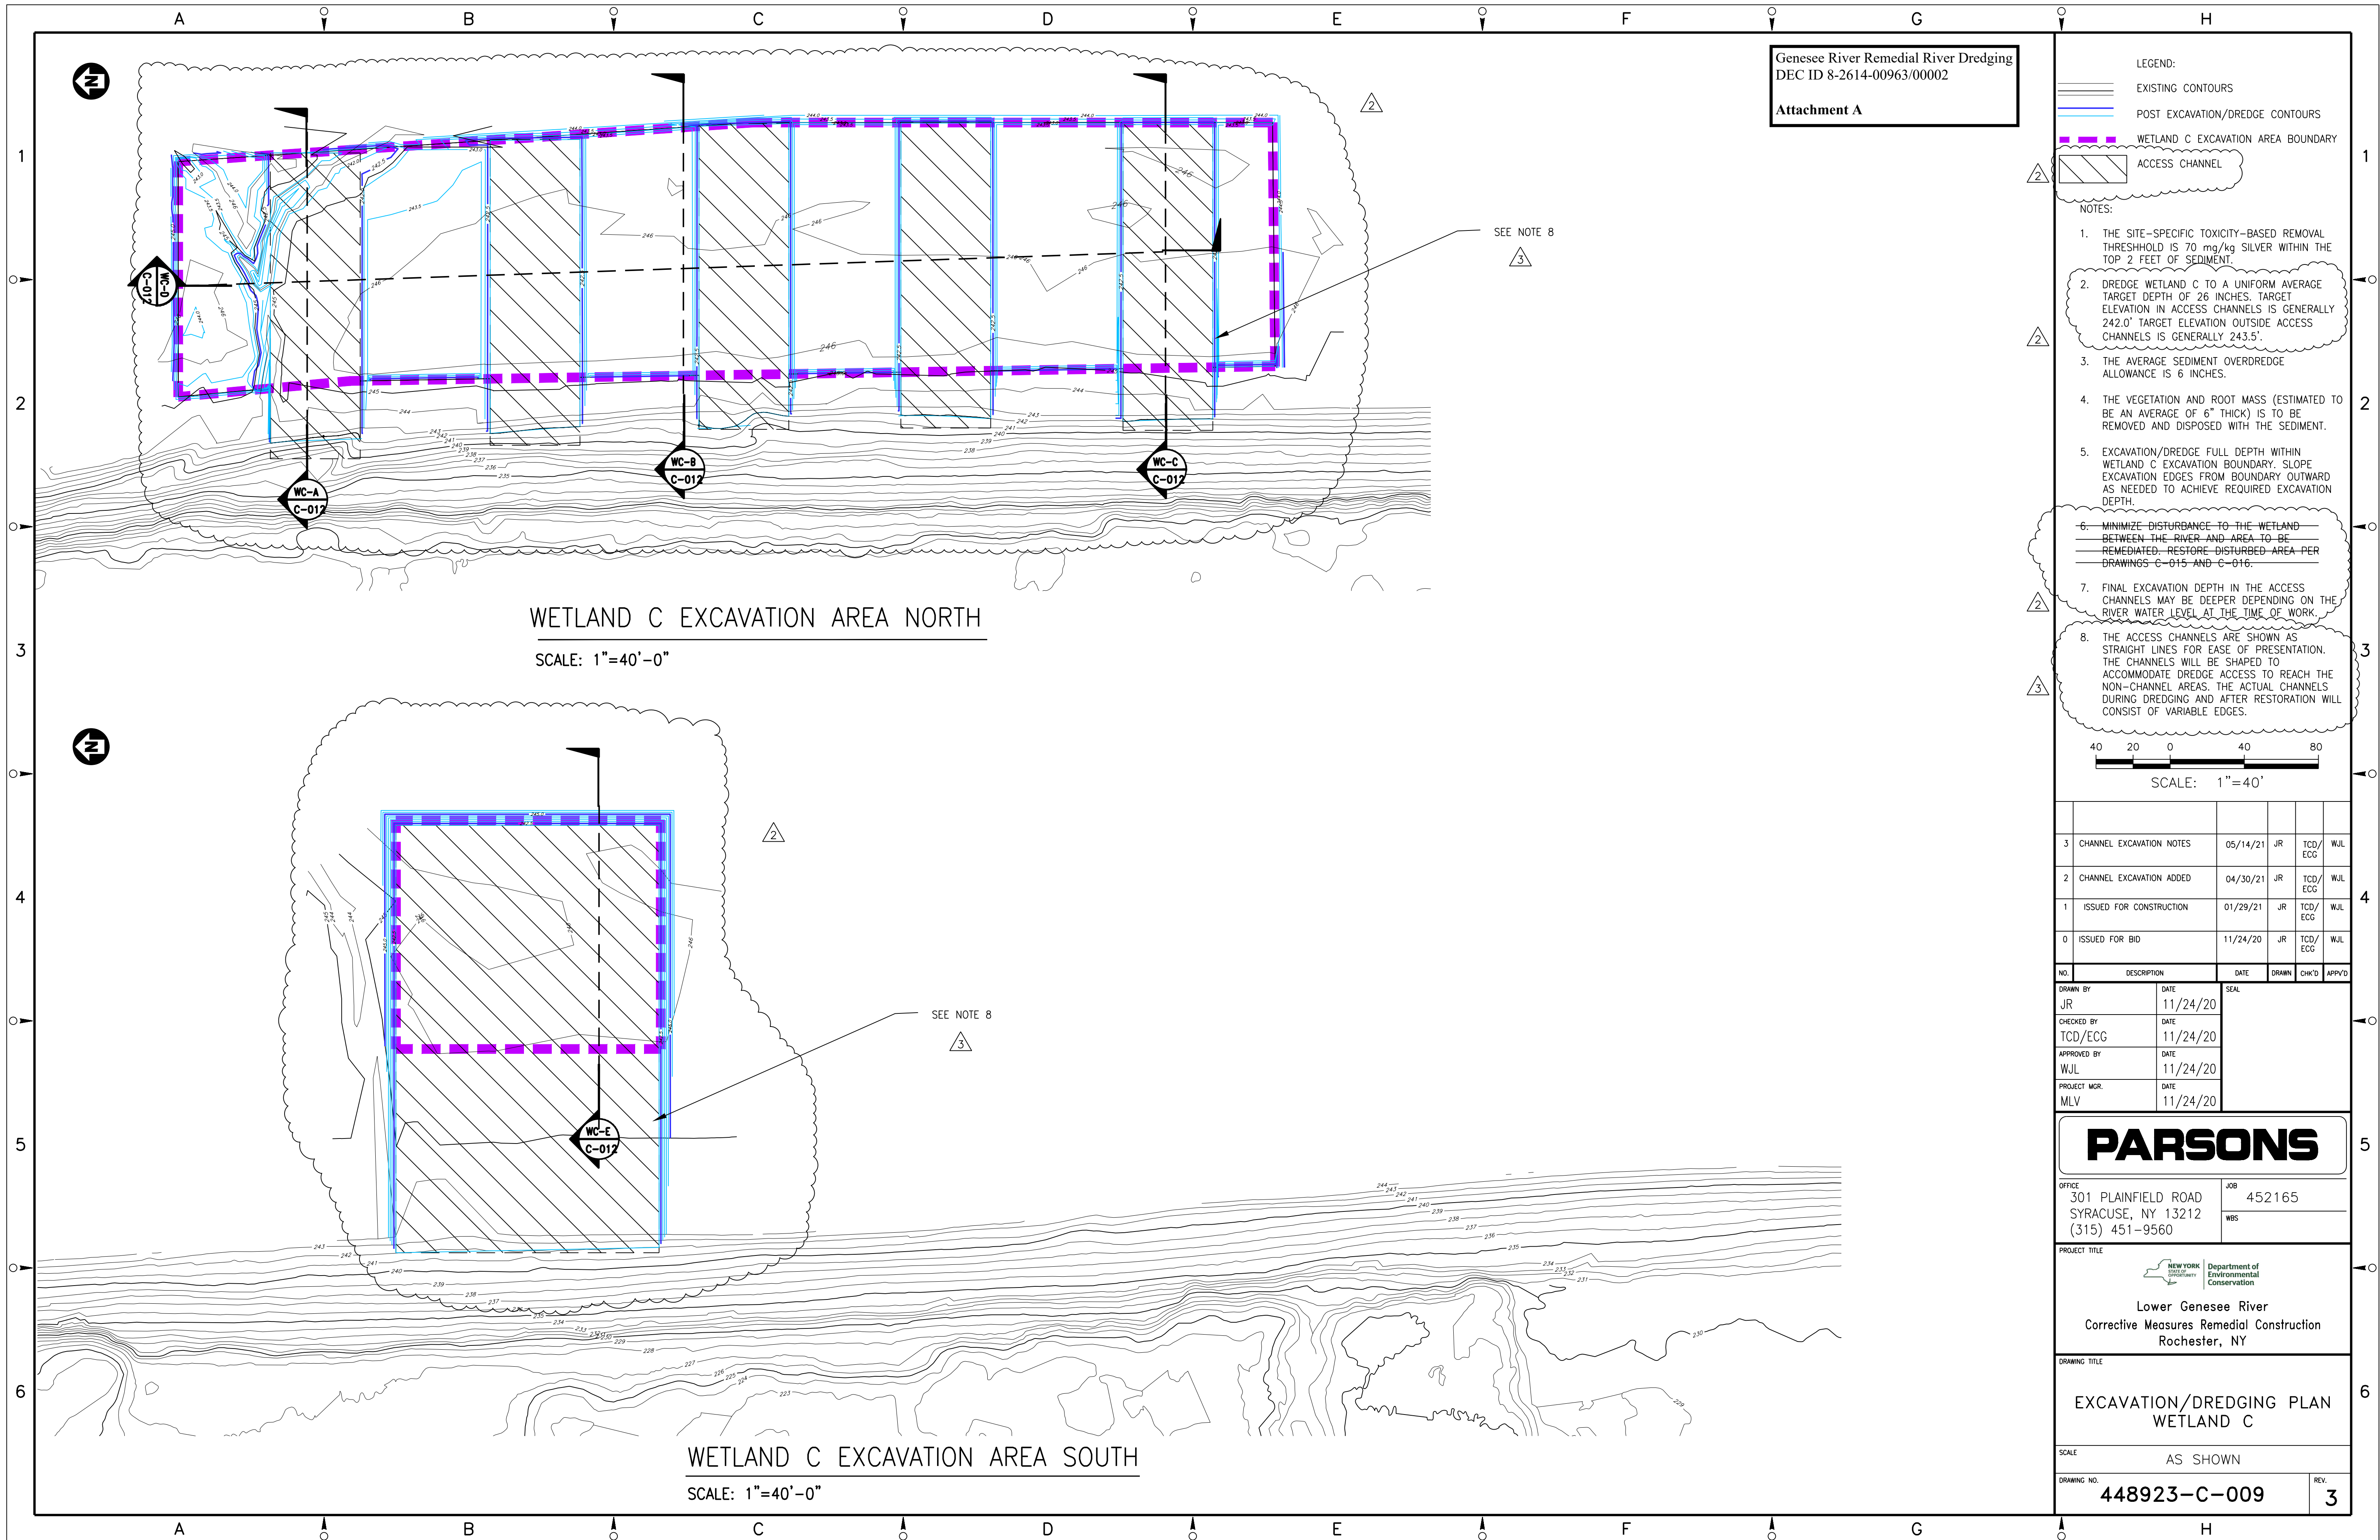


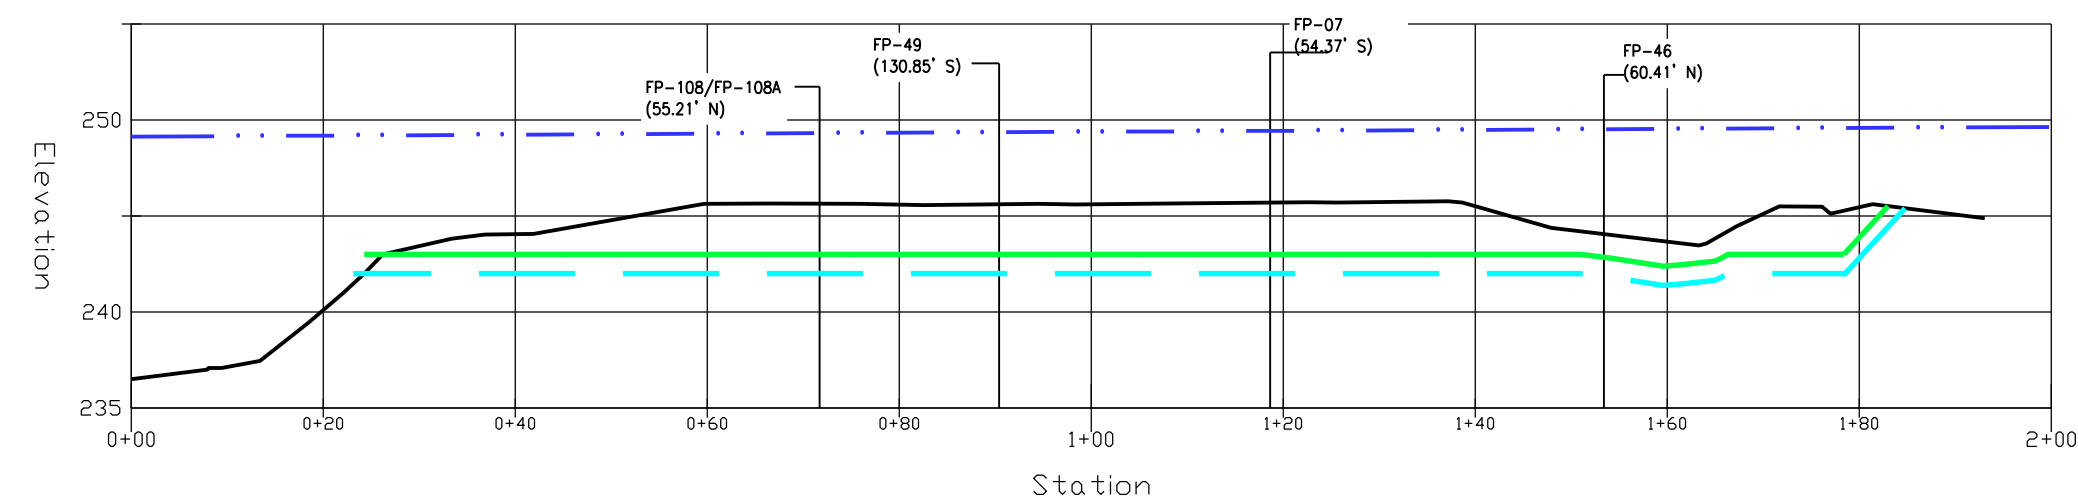

WA-A WETLAND C NORTH - CROSS SECTION A  
C-004  
C-009  
C-015

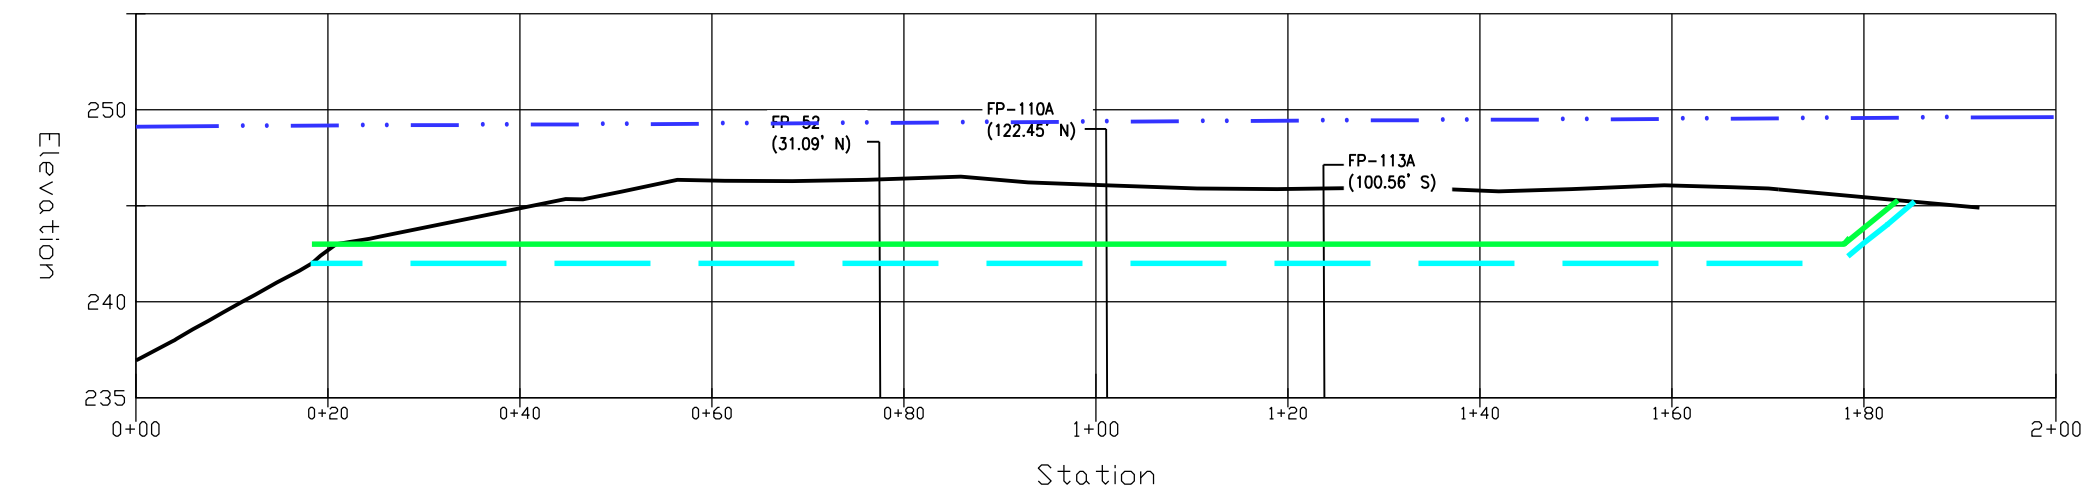

WA-C WETLAND C NORTH - CROSS SECTION C  
C-004  
C-009  
C-015

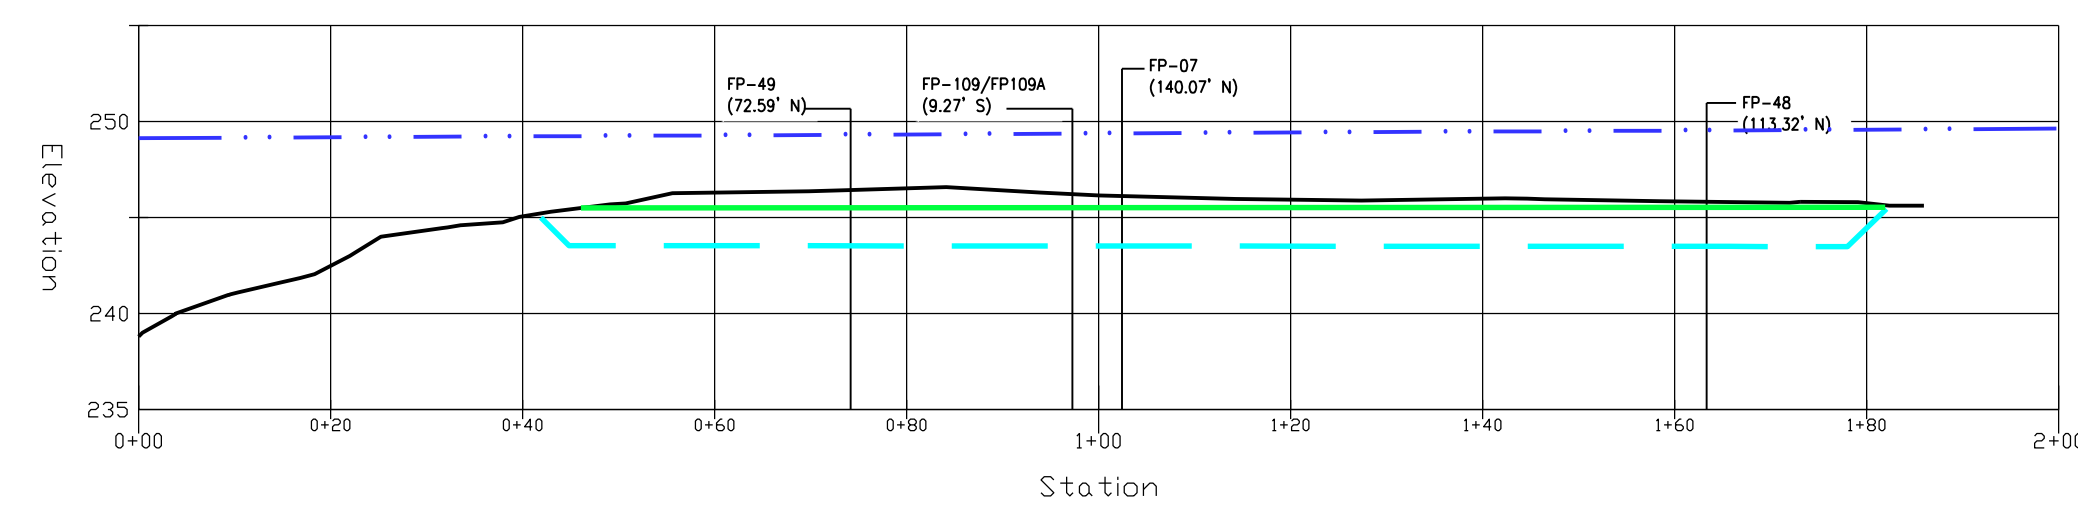


WA-B WETLAND C NORTH - CROSS SECTION B

C-004

C-009

C-015

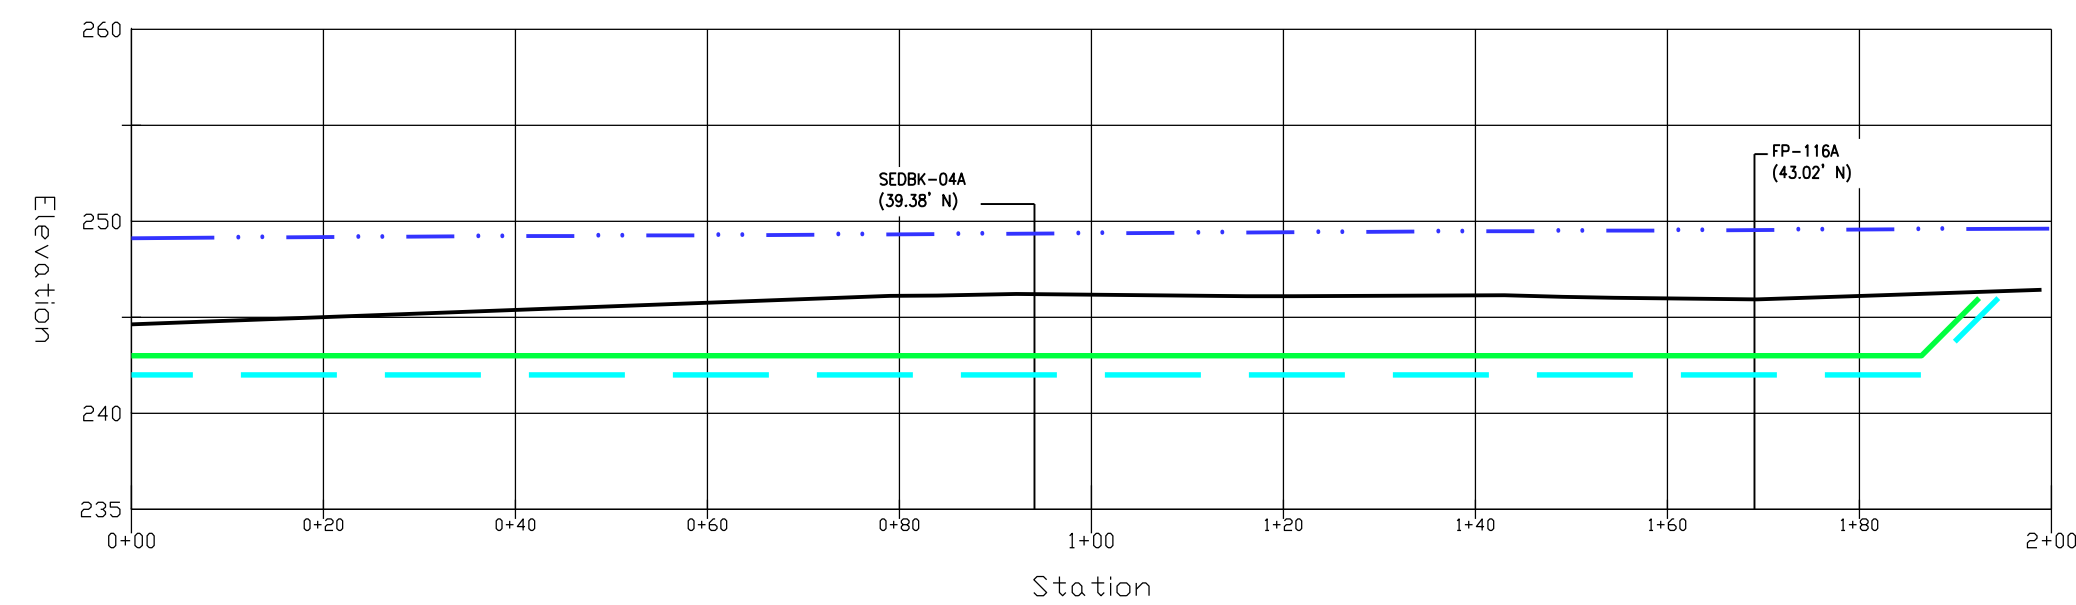


WA-E WETLAND C SOUTH - CROSS SECTION E

C-004

C-009

C-015

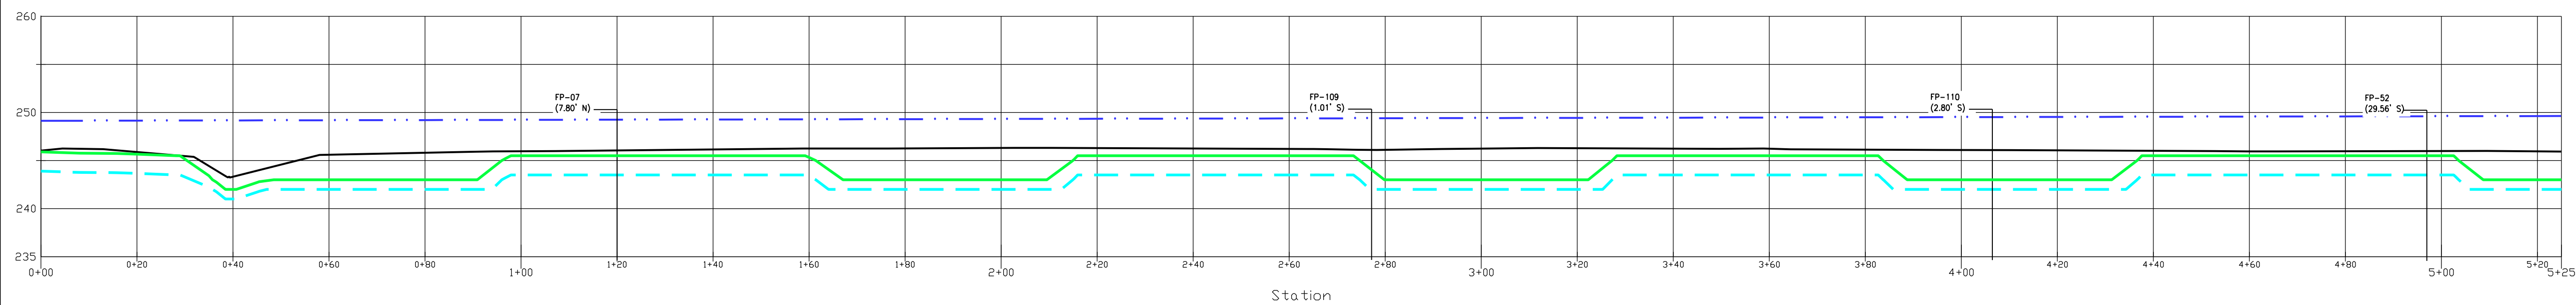

WA-D WETLAND C SOUTH - CROSS SECTION D  
C-004  
C-009  
C-015

Genesee River Remedial River Dredging  
DEC ID 8-2614-00963/00002

## Attachment A

LEGEND:

EXISTING GRADE

BACKFILL GRADE

— . . . — OHWM (ORDINARY HIGH WATER MARK)  
APPROX 249.13' (SEE NOTE 1)

NOTES:

1. OWHM - THE ORDINARY HIGH WATER MARK IN THIS SECTION OF THE LOWER GENESEE RIVER WAS COLLECTED BY PARSONS ON MARCH 18, 2020, USING FIELD OBSERVATIONS IN ACCORDANCE WITH THE UNITED STATES ARMY CORPS OF ENGINEERS (USACE) REGULATORY GUIDANCE LETTER No. 05-05. THE OWHM WAS MEASURED AT 249.13 FEET (DATUM NAVD 88).

2. NYS FRESHWATER WETLAND RH-21/NATIONAL WETLANDS INVENTORY WETLAND PEM1E IS REFERRED TO AS WETLAND C.

3. THE ACCESS CHANNELS ARE SHOWN AS STRAIGHT LINES FOR EASE OF PRESENTATION. THE CHANNELS WILL BE SHAPED TO ACCOMMODATE DREDGE ACCESS TO REACH THE NON-CHANNEL AREAS. THE ACTUAL CHANNELS DURING DREDGING AND AFTER RESTORATION WILL CONSIST OF VARIABLE EDGES.



SCALE: 1"=20'


3	CHANNEL EXCAVATION NOTES	05/14/21	JR	TCD/ ECG		WJL	
2	CHANNEL EXCAVATION ADDED	04/30/21	JR	TCD/ ECG		WJL	
1	ISSUED FOR CONSTRUCTION	01/29/21	JR	TCD/ ECG		WJL	
0	ISSUED FOR BID	11/24/20	JR	TCD/ ECG		WJL	

NO.	DESCRIPTION	DATE	DRAWN	CHKD	APPROV
DRAWN BY JR	DATE 11/24/20	SEAL			
CHECKED BY TCD/ECG	DATE 11/24/20				
APPROVED BY WJL	DATE 11/24/20				
PROJECT MGR. MLV	DATE 11/24/20				

**PARSONS**

OFFICE  
301 PLAINFIELD ROAD  
SYRACUSE, NY 13212  
(315) 451-9560

JOB	452165
WBS	

PROJECT TITLE	
	Department of Environmental Conservation
Lower Genesee River Corrective Measures Remedial Construction Rochester, NY	

DRAWING TITLE


CROSS SECTIONS  
WETLAND C

SCALE AS SHOWN

DRAWING NO.  
**448923-C-012**

3



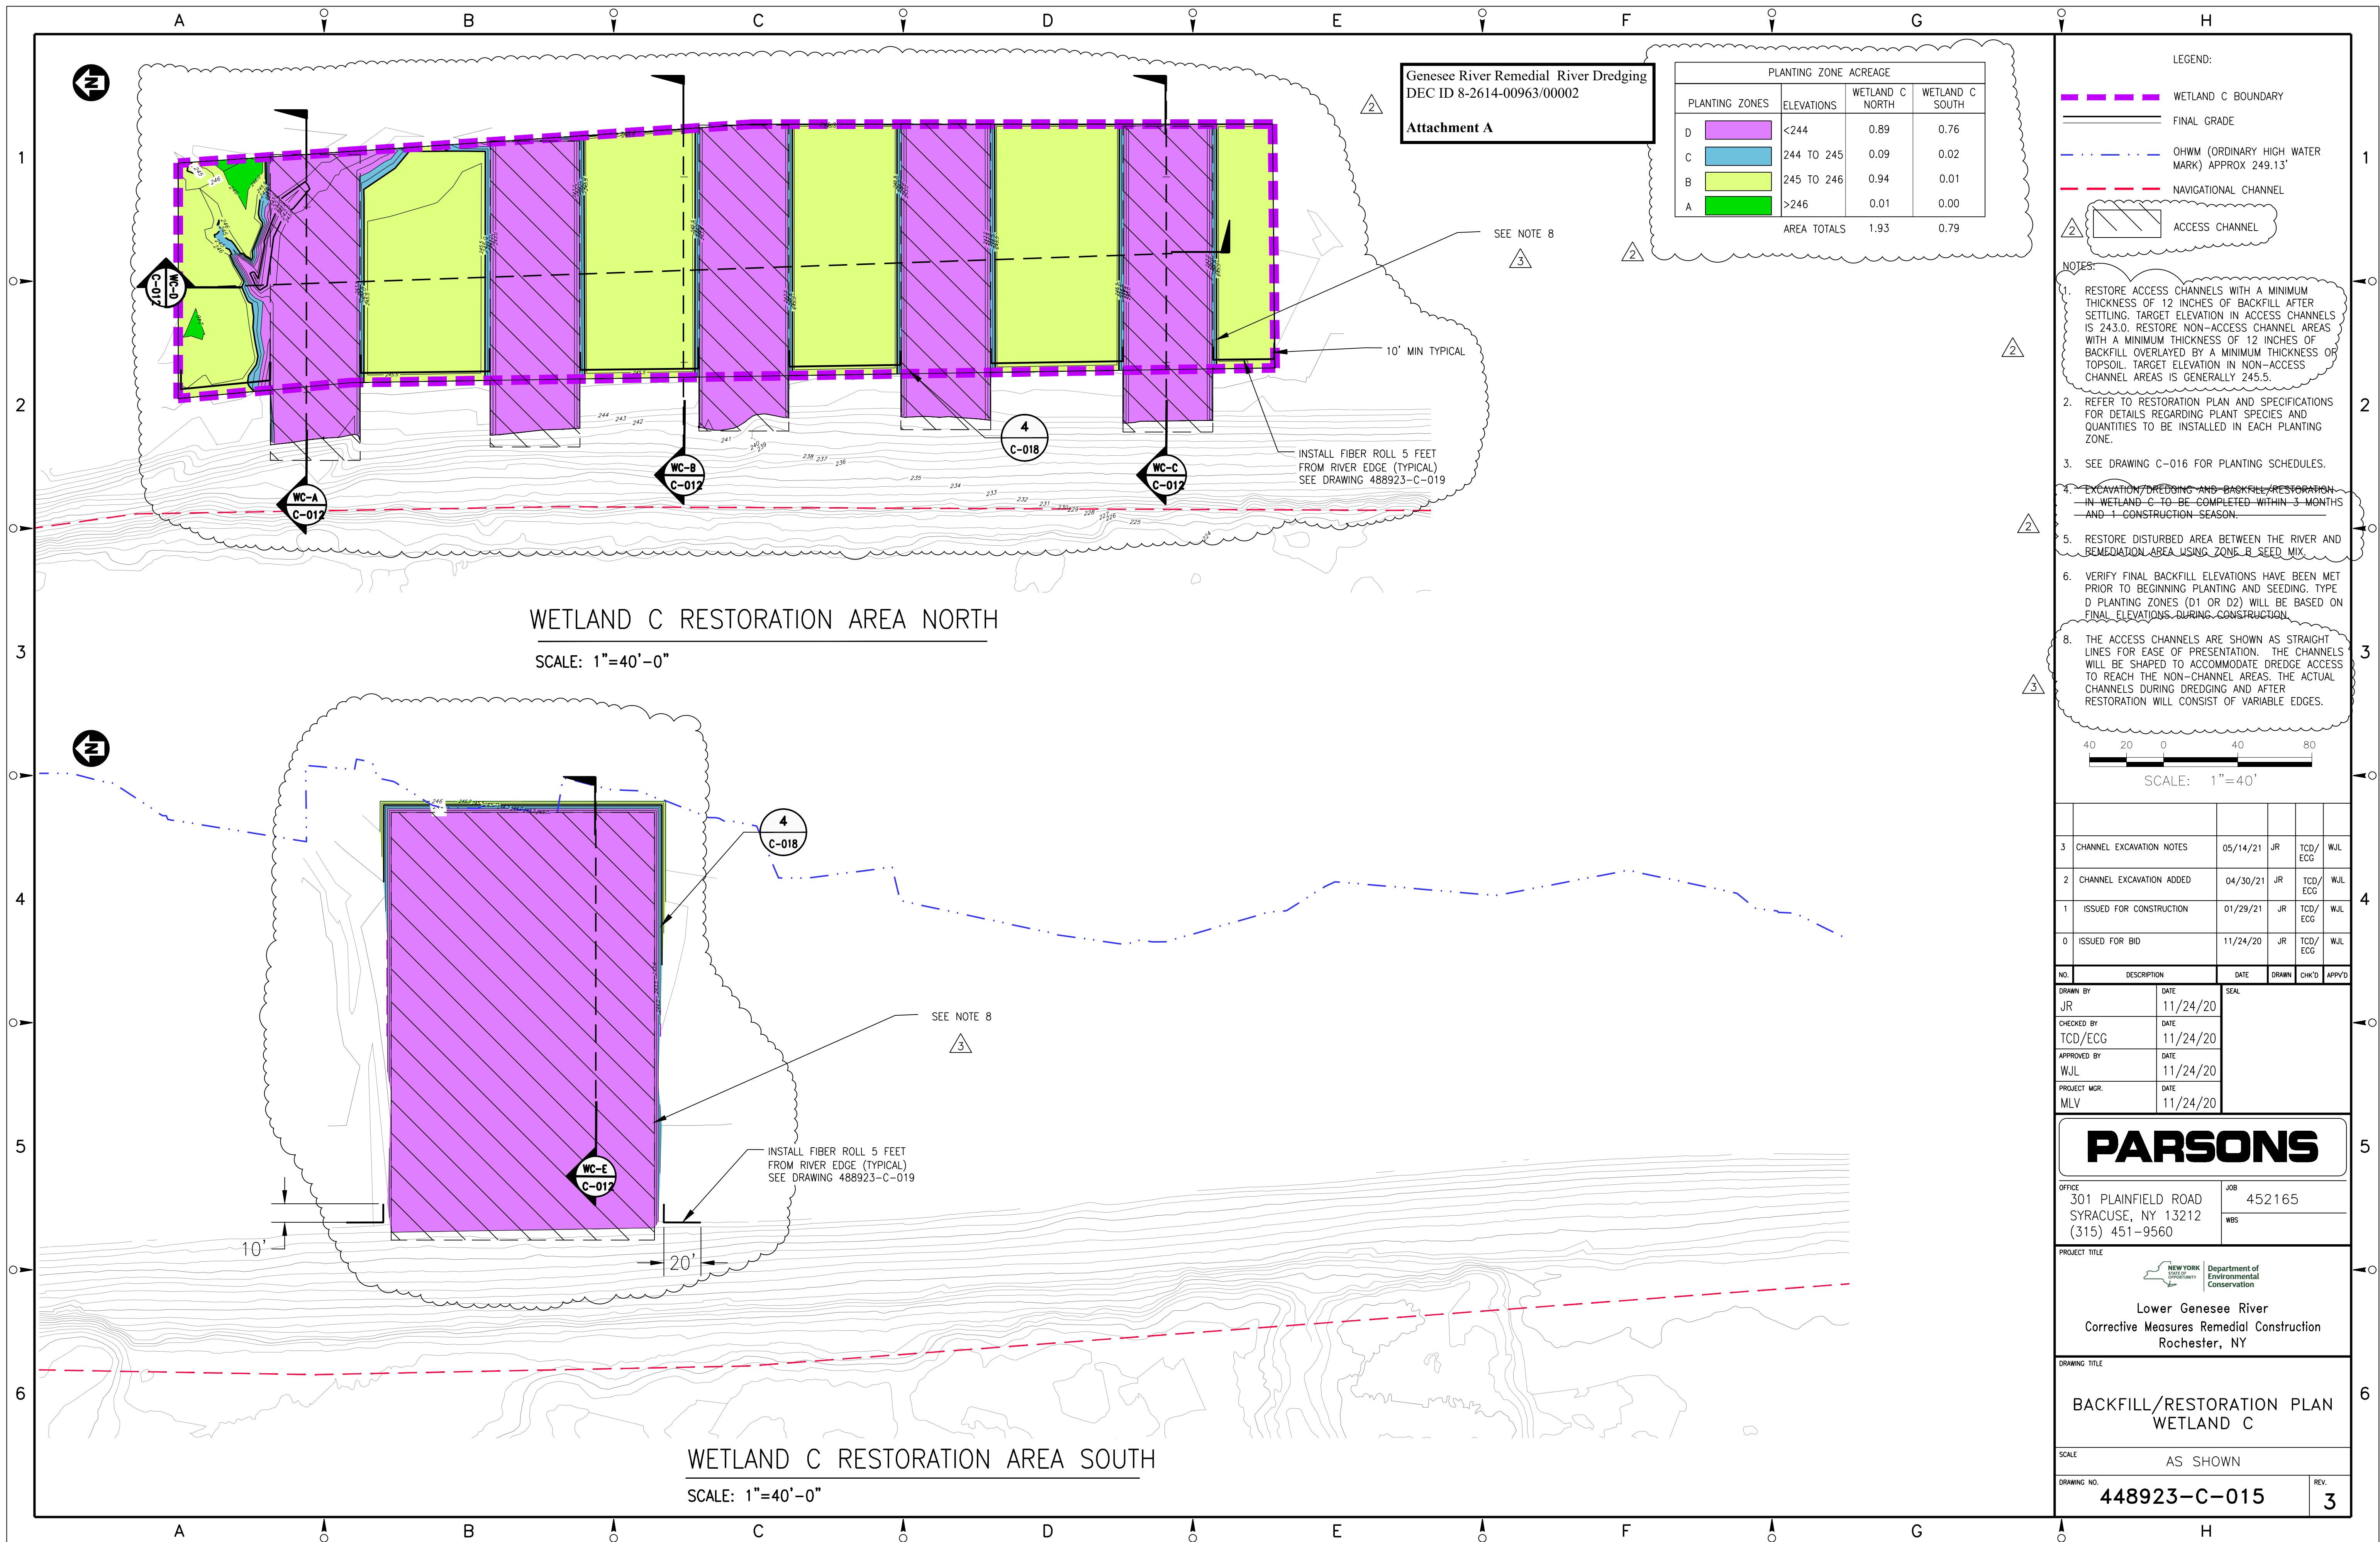



### PARTICLE SIZE DISTRIBUTION FOR TOPSOIL LAYER

HABITAT/EROSION PROTECTION LAYER WILL CONSIST OF COARSE GRAVEL WITH A  $D_{50} \geq 40$  MM, A RELATIVELY UNIFORM STONE SIZE ( $D_{85}/D_{15} \leq 2.5$ ) AND A MAXIMUM PARTICULAR SIZE OF 4 INCHES. THE GRAVEL SHALL BE EQUAL TO OR COARSER THAN THE APPROXIMATE GRADATION SHOWN IN TABLE 2

- | Grain Size (inches) | Grain Size (mm) | Percent Passing (Dry Weight Basis) |
|---------------------|-----------------|------------------------------------|
| 4                   | 100             | 100                                |
| 2 1/2               | 63              | ≤85                                |
| 1 1/2               | 40              | ≤50                                |
| 1                   | 25              | ≤15                                |
| 1/2                 | 13              | 0 TO 3                             |

Grain Size (inches or U.S. Sieve Size)	Grain Size (mm)	Percent Passing (Dry Weight Basis)
3/4	191	100
3/8	0	85-100
#4	4.76	70-100
#8	2.38	55-100
#16	1.19	42-63
#30	0.595	28-44
#50	0.297	≥15
#80	0.177	≤15
No. 200	0.075	≤5

2 WETLAND RESTORATION PLANTINGS  
NOT TO SCALE

KINGS LANDING AREA SURVEY				RIVER SURVEY			
POINT	NORTHING	EASTING	ELEVATION	POINT	NORTHING	EASTING	ELEVATION
CB10	1167569.5461	1404356.8630	254.050	BM-1	1167477.30	1404354.81	266.11
CB20	1167818.5910	1404159.9663	250.910	(X-CUT ON NORTH RIM MH)			
CB30	1167742.2008	1404024.5435	265.691				
CB40	1168137.5659	1403728.4578	271.864	BM-2	1167724.78	1404053.44	268.54
				(BOX CUT)			

SURVEY NOTES:

1. BATHYMETRIC RIVER SURVEYS CONDUCTED BY AQUA SURVEY, FLEMINGTON, NJ ON SEPTEMBER 8-9, 2015 AND JULY 22-24, 2019.
2. KLWWTP STAGING AREA SURVEYS CONDUCTED BY POPLI DESIGN GROUP, PENFIELD, NY ON AUGUST 1-7, 2019 AND APRIL 6-7, 2020.

Wetland Restoration Area Plantings and Seeding					Wetland Restoration Seed Mix Species Composition					
Restoration Area	Species		Stock Type	Installation rate (# per acre)	Restoration Area	Seed Mix Composition		Quantity (Pounds/Acre)	Percent	
	Common Name	Scientific Name				Common Name	Scientific Name			
A  (Elevation 246' to 247')	Swetflag	<i>Acorus americanus</i>	2" Plug	250	A  (Elevation 246' to 247')	Water plantain	<i>Alisma subcordatum</i>	0.8	3.10%	
	Water plantain	<i>Alisma subcordatum</i>	2" Plug	250		Swamp milkweed	<i>Asclepias incarnata</i>	0.2	0.60%	
	Water sedge	<i>Carex aquatilis</i>	2" Plug	250		Nodding beggar ticks	<i>Bidens cernua</i>	0.2	0.60%	
	Lake sedge	<i>Carex lasiocarpus</i>	2" Plug	250		Lake sedge	<i>Carex lurida</i>	1.6	6.30%	
	Water willow	<i>Decodon verticillatus</i>	2" Plug	750		Blunt broom sedge	<i>Carex scoparia</i>	1.6	6.30%	
	Willow weed	<i>Jussiaea americana</i>	2" Plug	750		Fox sedge	<i>Carex vulpinoidea</i>	3.1	12.50%	
	Arrow arum	<i>Peltandra virginica</i>	2" Plug	250		Rice cutgrass	<i>Leersia oryzoides</i>	3.1	12.50%	
	Water smartweed	<i>Persicaria amphibia</i>	2" Plug	2,500		Spikenush	<i>Eleocharis palustris</i>	1.6	6.30%	
	Pickering-weed	<i>Portulandra corata</i>	2" Plug	2,500		Riverbank wild rye	<i>Elymus riparius</i>	3.1	12.50%	
	Arrowhead	<i>Sagittaria latifolia</i>	2" Plug	300		Fowl mannagrass	<i>Glyceria striata</i>	0.2	0.60%	
	Deep water potato	<i>Sagittaria rigida</i>	2" Plug	500		Common sneezeweed	<i>Helianthus autumnale</i>	0.2	0.60%	
	Hardstem bulrush	<i>Scheuchzeria palustris</i>	2" Plug	500		Soft rush	<i>Juncus effusus</i>	1.6	6.30%	
	Three-square	<i>Scheuchzeria palustris</i>	2" Plug	350		Great water lobelia	<i>Lobelia siphilitica</i>	0.2	0.60%	
	Soft-stem bulrush	<i>Scheuchzeria palustris</i>	2" Plug	500		Fowl bluggass	<i>Poa palustris</i>	1.6	6.30%	
	Green bulrush	<i>Scirpus atrovirens</i>	2" Plug	500		Green bulrush	<i>Scirpus atrovirens</i>	0.8	3.10%	
	Eastern burmed	<i>Sporangium americanum</i>	2" Plug	300		Woolgrass	<i>Scirpus cyperinus</i>	0.8	3.10%	
	Giant burmed	<i>Sporangium eurycarpum</i>	2" Plug	300		Leafy bulrush	<i>Scirpus polyphyllus</i>	0.8	3.10%	
	Wetland Seed Mix A <sup>1</sup>	Seed (lbs)	25			Giant burmed	<i>Sporangium eurycarpum</i>	3.1	12.50%	
	Winter Rye	<i>Secale cereal</i>	Seed (lbs)	15		Blue vervain	<i>Verbena hastata</i>	0.8	3.10%	
	Wild rice <sup>4</sup>	<i>Zizania aquatica</i>	Seed (lbs)	75				Total	25	100%
B  (Elevation 245' to 246')	Water willow	<i>Decodon verticillatus</i>	2" Plug	1,000	B  (Elevation 245' to 246')	Water plantain	<i>Alisma subcordatum</i>	2.3	9.40%	
	Willow weed	<i>Jussiaea americana</i>	2" Plug	1,000		Swamp milkweed	<i>Asclepias incarnata</i>	0.2	0.60%	
	Yellow water lily	<i>Nuphar lutea</i>	2" Plug/Tuber	500		Nodding beggar ticks	<i>Bidens cernua</i>	0.2	0.60%	
	White water lily	<i>Nymphaea odorata</i>	2" Plug/Tuber	500		Lake sedge	<i>Carex lurida</i>	0.8	3.10%	
	Water smartweed	<i>Persicaria amphibia</i>	2" Plug	3,000		Blunt broom sedge	<i>Carex scoparia</i>	0.8	3.10%	
	Pickering-weed	<i>Portulandra corata</i>	2" Plug	3,000		Fox sedge	<i>Carex vulpinoidea</i>	0.8	3.10%	
	Deep water potato	<i>Sagittaria rigida</i>	2" Plug	100		Spikenush	<i>Eleocharis palustris</i>	3.1	12.50%	
	Soft-stem bulrush	<i>Scheuchzeria palustris</i>	2" Plug	250		Riverbank wild rye	<i>Elymus riparius</i>	1.6	6.30%	
	Green bulrush	<i>Scirpus atrovirens</i>	2" Plug	250		Fowl mannagrass	<i>Glyceria striata</i>	0.3	1.30%	
	Eastern burmed	<i>Sporangium americanum</i>	2" Plug	250		Common sneezeweed	<i>Helianthus autumnale</i>	0.2	0.60%	
	Giant burmed	<i>Sporangium eurycarpum</i>	2" Plug	250		Soft rush	<i>Juncus effusus</i>	1.6	6.30%	
	Narrow leaf cattail	<i>Typha angustifolia</i>	2" Plug	900		Rice cutgrass	<i>Leersia oryzoides</i>	3.1	12.50%	
	Wetland Seed Mix B <sup>1</sup>	Seed (lbs)	25			Green bulrush	<i>Scirpus atrovirens</i>	1.6	6.30%	
	Winter Rye	<i>Secale cereal</i>	Seed (lbs)	15		Woolgrass	<i>Scirpus cyperinus</i>	0.8	3.10%	
	Wild rice <sup>4</sup>	<i>Zizania aquatica</i>	Seed (lbs)	75		Leafy bulrush	<i>Scirpus polyphyllus</i>	0.8	3.10%	
	Water willow	<i>Decodon verticillatus</i>	2" Plug	1,000		Giant burmed	<i>Sporangium eurycarpum</i>	6.3	25.00%	
	Willow weed	<i>Jussiaea americana</i>	2" Plug	1,500		Blue vervain	<i>Verbena hastata</i>	0.8	3.10%	
	Yellow water lily	<i>Nuphar lutea</i>	2" Plug/Tuber	2,500				Total	25	100%
	White water lily	<i>Nymphaea odorata</i>	2" Plug/Tuber	2,500		C (Elevation 244' to 245')	No seed mix			
	Water smartweed	<i>Persicaria amphibia</i>	2" Plug	2,500			D1 and D2 (Elevation <244')	No seed mix		
Pickering-weed	<i>Portulandra corata</i>	2" Plug	1,000							
Wild rice <sup>4</sup>	<i>Zizania aquatica</i> or <i>palustris</i>	Seed (lbs)	100							
D1  (Elevation 243' to 244')	Coontail	<i>Ceratophyllum demersum</i>	Whole Plant/Tuber	1,500						
	Yellow water lily	<i>Nuphar lutea</i>	2" Plug/Tuber	1,750						
D2  (Elevation <243')	White water lily	<i>Nymphaea odorata</i>	2" Plug/Tuber	1,750						
	Sago pondweed	<i>Stuckenia pectinata</i>	Whole Plant/Tuber	1,500						
	Wild celery	<i>Valisneria spiralis</i>	Whole Plant/Tuber	1,500						
	Wild rice <sup>4</sup>	<i>Zizania aquatica</i> or <i>palustris</i>	Seed (lbs)	100						
	Coontail	<i>Ceratophyllum demersum</i>	Whole Plant/Tuber	2,400						
	Yellow water lily	<i>Nuphar lutea</i>	2" Plug/Tuber	400						
	White water lily	<i>Nymphaea odorata</i>	2" Plug/Tuber	400						
	Sago pondweed	<i>Stuckenia pectinata</i>	Whole Plant/Tuber	2,400						
Wild celery	<i>Valisneria spiralis</i>	Whole Plant/Tuber	2,400							
Wild rice <sup>4</sup>	<i>Zizania aquatica</i> or <i>palustris</i>	Seed (lbs)	100							

<sup>1</sup> Refer to Table 32 T2 00-2 for species composition of seed mix.

For the river access area, use the wetland seed mix that is appropriate for the final elevation. Plant areas with a final elevation above Zone A (246' to 247') with a general lawn mix.

## Attachment A

2	CHANNEL EXCAVATION ADDED	04/30/21	JR	TCD/ ECG	WJL				
1	ISSUED FOR CONSTRUCTION	01/29/21	JR	TCD/ ECG	WJL				
0	ISSUED FOR BID	11/24/20	JR	TCD/ ECG	WJL				
NO.	DESCRIPTION	DATE	DRAWN	CHK'D	APP'VD				
DRAWN BY	DATE	SEAL							
JR	11/24/20								
CHECKED BY	DATE								
TCD/ECG	11/24/20								
APPROVED BY	DATE								
WJL	11/24/20								
PROJECT MGR.	DATE								
MLV	11/24/20								

# PARSONS

OFFICE  
301 PLAINFIELD ROAD  
SYRACUSE, NY 13212  
(315) 451-9560

JOB	
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WBS

PROJECT TITLE	
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Department of  
Environmental  
Conservation

Lower Genesee River  
Corrective Measures Remedial Construction  
Rochester, NY

DRAWING TITLE

# DETAIL SHEET

SCALE NONE

DRAWING NO.

448923-C-016

REV





# NEW YORK STATE DEPARTMENT OF ENVIRONMENTAL CONSERVATION

## Division of Environmental Permits, Region 8

6274 East Avon-Lima Road, Avon, NY 14414-9516

P: (585) 226-5400 | F: (585) 226-2830

www.dec.ny.gov

## NOTICE OF INTENT TO COMMENCE WORK

Date: \_\_\_\_\_

NYS Department of Environmental Conservation  
Division of Environmental Permits  
6274 East Avon-Lima Road  
Avon, NY 14414

Re: 401 Water Quality Certification  
DEC Permit No. 8-2614-00963/00002

In accordance with Condition #3 of the referenced permit, I hereby serve notice to commence work on or about \_\_\_\_\_, 20\_\_\_\_. Notice of project completion will be submitted within one week after termination of all work.

This is also to certify that, having read in entirety the permit, I am fully aware of and understand the general, supplemental and special conditions, and agree to comply in all respects to those requirements. I further understand that prior to undertaking any modification to the authorized project, I must seek and receive the written approval of the Regional Permit Administrator.

## WARNING

The Permittee and the contractor (if any) are required to follow all permit conditions. Violation of permit conditions may lead to legal action, including the imposition of substantial monetary fines and corrective work.

\_\_\_\_\_  
Signature of Permittee

\_\_\_\_\_  
Signature of Contractor (if any)

\_\_\_\_\_  
Contractor's Address

\_\_\_\_\_  
Contractor's Telephone Number

\_\_\_\_\_  
Signature of Landowner(s)

Attention Permittee and/or Contractor: Please fold as noted on the back and return.



Department of  
Environmental  
Conservation

(Fold # 2)

Place  
Stamp  
Here

NYS Department of Environmental Conservation  
Attn: Environmental Permits  
6274 E Avon-Lima Rd  
Avon, NY 14414

(Fold # 1 – Staple Here)



## Department of Environmental Conservation

# NOTICE

The Department of Environmental Conservation (DEC) has issued permit(s) pursuant to the Environmental Conservation Law for work being conducted at this site. For further information regarding the nature and extent of work approved and any Departmental conditions on it, contact the Regional Permit Administrator listed below. Please refer to the permit number shown when contacting the DEC.

Regional Permit Administrator

Permit Number      8-2614-00936/00002

Expiration Date      12/31/2027

Thomas P Haley  
6274 E Avon-Lima Rd  
Avon, NY 14414  
(585) 226-5400

NOTE: This notice is **NOT** a permit