
CELA REUSE SPOIL DISPOSAL AREA

FORMER SINCLAIR REFINERY SITE **WELLSVILLE, NEW YORK**

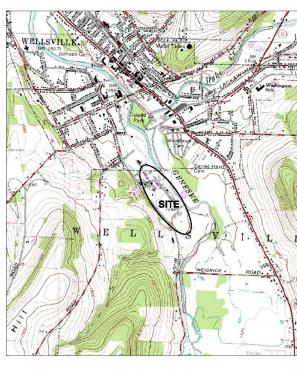

SCALE: 1"=1500'

G-03 TITLE SHEET C-16 SITE PLAN AND PROPOSED FILL AREA C-17 OPTION 1 EXCAVATION ELEVATIONS AND WATER COLLECTION SYSTEM C-18 OPTION 1 SPOIL PLACEMENT ELEVATIONS C-19 OPTION 1 CAP SYSTEM ELEVATIONS C-20 OPTION 1 FINAL GRADING AND CROSS-SECTION PLAN C-21 OPTION 1 CROSS-SECTIONS C-22 OPTION 2 EXCAVATION ELEVATIONS AND WATER COLLECTION SYSTEM C-23 OPTION 2 SPOIL PLACEMENT ELEVATIONS C-24 OPTION 2 CAP SYSTEM ELEVATIONS C-25 OPTION 2 FINAL GRADING AND CROSS-SECTIONS C-26 **OPTION 2 CROSS-SECTIONS** C-27 DETAILS I C-28 **DETAILS II**



NOT TO SCALE

ISSUED FOR BIDDING ADDENDUM REVISIONS

ADDENDUM DATE

ISSUED FOR CONSTRUCTION

DESCRIPTION

FOR REVIEW ONLY NOT FOR CONSTRUCTION

RECORD DRAWINGS

DRAWN DES DATE MAR 2009 CHECKED JDM JOB # 13812458 SCALE: AS SHOWN

> FORMER SINCLAIR REFINERY WELLSVILLE, NY **CELA REUSE SPOIL**


DISPOSAL AREA

TITLE SHEET

URS

G-03

LOCATION MAP

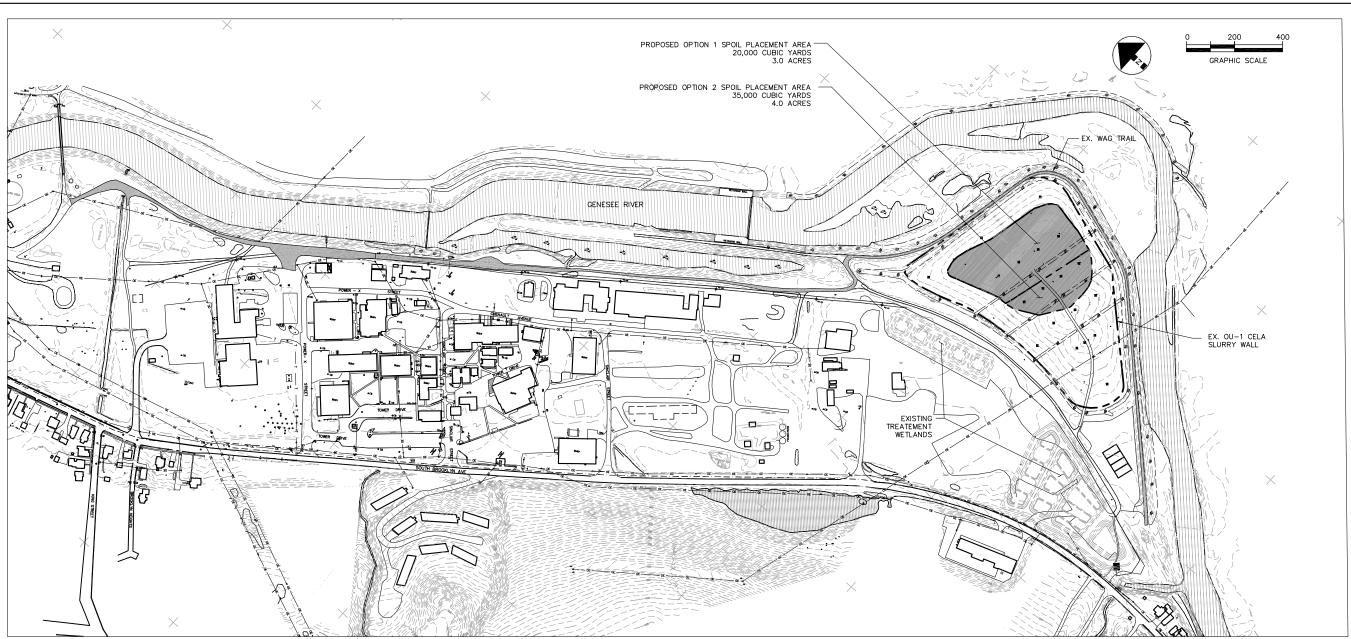

OPTION 1 SEQUENCE OF CONSTRUCTION 20,000 CUBIC YARDS TOTAL PLACED OVER 3.0 ACRES

- 1. INSTALL EROSION AND SEDIMENT CONTROLS AROUND CELA SPOIL PLACEMENT AREA.
- 2. REMOVE EXISTING RIP RAP FROM FINGER DRAINS AND STOCKPILE FOR USE IN RIVER REMEDIATION ACTIVITIES.
- STRIP EXISTING 6" TOPSOIL LAYER WITHIN OPTION 1 SPOIL PLACEMENT AREA AND STOCKPILE FOR RE-USE. STRIP
 ADDITIONAL 6" EXISTING COMMON SOIL WITHIN OPTION 1 SPOIL PLACEMENT AREA AND STOCKPILE FOR RE-USE. REFER
 TO SHEET C-17.
- 4. EXCAVATE TO EXPOSE 5 FOOT WIDE STRIP OF EXISTING CAP SYSTEM GEOSYNTHETICS AROUND PERIMETER OF SPOIL DISPOSAL AREA. CREATE TEMPORARY BERM ALONG OUTSIDE OF SPOIL PLACEMENT AREA USING EXCAVATED SOIL.
- CUT EXISTING GEOCOMPOSITE TO EXPOSE EXISTING GEOMEMBRANE. EXTRUSION WELD GEOMEMBRANE FLAP TO EXISTING GEOMEMBRANE. GEOMEMBRANE FLAP SHALL EXTEND BEYOND LIMIT OF SPOIL PLACEMENT AS SHOWN ON DETAIL 7, SHEET C-28.
- INSTALL OPTION 1 WATER DRAINS AND WATER COLLECTION PIPING AS SHOWN ON SHEET C-17.
- 7. PLACE OPTION 1 SPOIL MATERIAL TO GRADES SHOWN ON SHEET C-18 (APPROX. 20,000 CUBIC YARDS).
- 8. FOLD BACK 40 MIL LLDPE MEMBRANE FLAP AND REMOVE TEMPORARY BERM.
- EXCAVATE ANCHOR TRENCH BEYOND LIMIT OF SPOIL PLACEMENT FOR TERMINATION OF CAP SYSTEM GEOSYNTHETICS. EXCAVATE ANCHOR TRENCH TO EXISTING LINER SYSTEM GEOSYNTHETICS (TOP OF EXISTING GEOCOMPOSITE DRAINAGE LAYER).
- 10. PLACE 40 MIL LLDPE MEMBRANE FLAP IN TRENCH.
- 11. INSTALL PROPOSED CAP SYSTEM GEOSYNTHETICS, TERMINATING GEOSYNTHETICS IN ANCHOR TRENCH.
- 12. BACKFILL ANCHOR TRENCH WITH AGGREGATE MATERIAL.
- 13. PLACE CAP SYSTEM COVER SOIL TO GRADES SHOWN ON C-19.
- 14. UPON COMPLETION OF THE CAP SYSTEM CONSTRUCTION THE CELA AREA SHALL BE SEEDED AND RESTORED IN ACCORDANCE WITH THE RESTORATION PLAN.

OPTION 2 SEQUENCE OF CONSTRUCTION 35,000 CUBIC YARDS TOTAL PLACED OVER 4.0 ACRES

- 1. INSTALL EROSION AND SEDIMENT CONTROLS AROUND CELA SPOIL PLACEMENT AREA.
- 2. REMOVE EXISTING RIP RAP FROM FINGER DRAINS AND STOCKPILE FOR USE IN RIVER REMEDIATION ACTIVITIES.
- 3. STRIP EXISTING 6" TOPSOIL LAYER WITHIN OPTION 2 SPOIL PLACEMENT AREA AND STOCKPILE FOR RE-USE. STRIP ADDITIONAL 6" EXISTING COMMON SOIL WITHIN OPTION 2 SPOIL PLACEMENT AREA AND STOCKPILE FOR RE-USE. REFER TO SHEET C-22.
- 4. EXCAVATE TO EXPOSE 5 FOOT WIDE STRIP OF EXISTING CAP SYSTEM GEOSYNTHETICS AROUND PERIMETER OF SPOIL DISPOSAL AREA. CREATE TEMPORARY BERM ALONG OUTSIDE OF SPOIL PLACEMENT AREA USING EXCAVATED SOIL.
- CUT EXISTING GEOCOMPOSITE TO EXPOSE EXISTING GEOMEMBRANE, EXTRUSION WELD GEOMEMBRANE FLAP TO EXISTING GEOMEMBRANE. GEOMEMBRANE FLAP SHALL EXTEND BEYOND LIMIT OF SPOIL PLACEMENT AS SHOWN ON DETAIL 7, SHEET C-28.
- 6. INSTALL OPTION 2 WATER DRAINS AND WATER COLLECTION PIPING AS SHOWN ON SHEET C-22.
- 7. PLACE OPTION 2 SPOIL MATERIAL TO GRADES SHOWN ON SHEET C-23 (APPROX. 35,000 CUBIC YARDS).
- 8. FOLD BACK 40 MIL LLDPE MEMBRANE FLAP AND REMOVE TEMPORARY BERM
- EXCAVATE ANCHOR TRENCH BEYOND LIMIT OF SPOIL PLACEMENT FOR TERMINATION OF CAP SYSTEM GEOSYNTHETICS. EXCAVATE ANCHOR TRENCH TO EXISTING LINER SYSTEM GEOSYNTHETICS (TOP OF EXISTING GEOCOMPOSITE DRAINAGE LAYER).
- 10. PLACE 40 MIL LLDPE MEMBRANE FLAP IN TRENCH.
- 11. INSTALL PROPOSED CAP SYSTEM GEOSYNTHETICS, TERMINATING GEOSYNTHETICS IN ANCHOR TRENCH.
- 12. BACKFILL ANCHOR TRENCH WITH AGGREGATE MATERIAL.
- 13. PLACE CAP SYSTEM COVER SOIL TO GRADES SHOWN ON C-24.
- 14. UPON COMPLETION OF THE CAP SYSTEM CONSTRUCTION THE CELA AREA SHALL BE SEEDED AND RESTORED IN ACCORDANCE WITH THE RESTORATION PLAN.

SURVEY INFORMATION

BENCHMARK #1 PSM2 - BRASS DISK IN CONCRETE NORTHING - 768045.92 (NAD 27) EASTING - 675839.57 ELEVATION - 1507.15 (NGVD 29)

BENCHMARK #2
PSM3 — BRASS DISK IN CONCRETE
NORTHING — 768452.57 (NAD 27)
EASTING — 675005.19
ELEVATION — 1506.39 (NGVD 29)

CONTRACTOR SHALL VERIFY ALL BENCHMARKS AND CONTROL POINTS PRIOR TO USE.

TOPOGRAPHIC INFORMATION GENERATED USING AERIAL PHOTOGRAPHY (1999) WITH A VERTICAL ACCURACY OF 0.5 TO 0.75 FEET AND GROUND CONTROL TIED TO THE STATE PLANE, NAD 27. NEW YORK WEST—3103, U.S. SURVEY FEET (HORIZONTAL) AND NGVD 29, U.S. SURVEY FEET (VERTICAL).

ADDENDUM REVISIONS

ADDENDUM NO ADDENDUM DATE BY

ISSUED FOR CONSTRUCTION

FOR REVIEW ONLY NOT FOR CONSTRUCTION

RECORD DRAWINGS

COPYRIGHT: ALL RIGHTS RESERVED.

DRAWN DES DATE MAR 2009
CHECKED JDM JOB # 13812458
SCALE: AS SHOWN


FORMER SINCLAIR REFINERY
WELLSVILLE, NY
CELA REUSE SPOIL


DISPOSAL AREA


SITE PLAN AND PROPOSED FILL AREA


URS


C-16

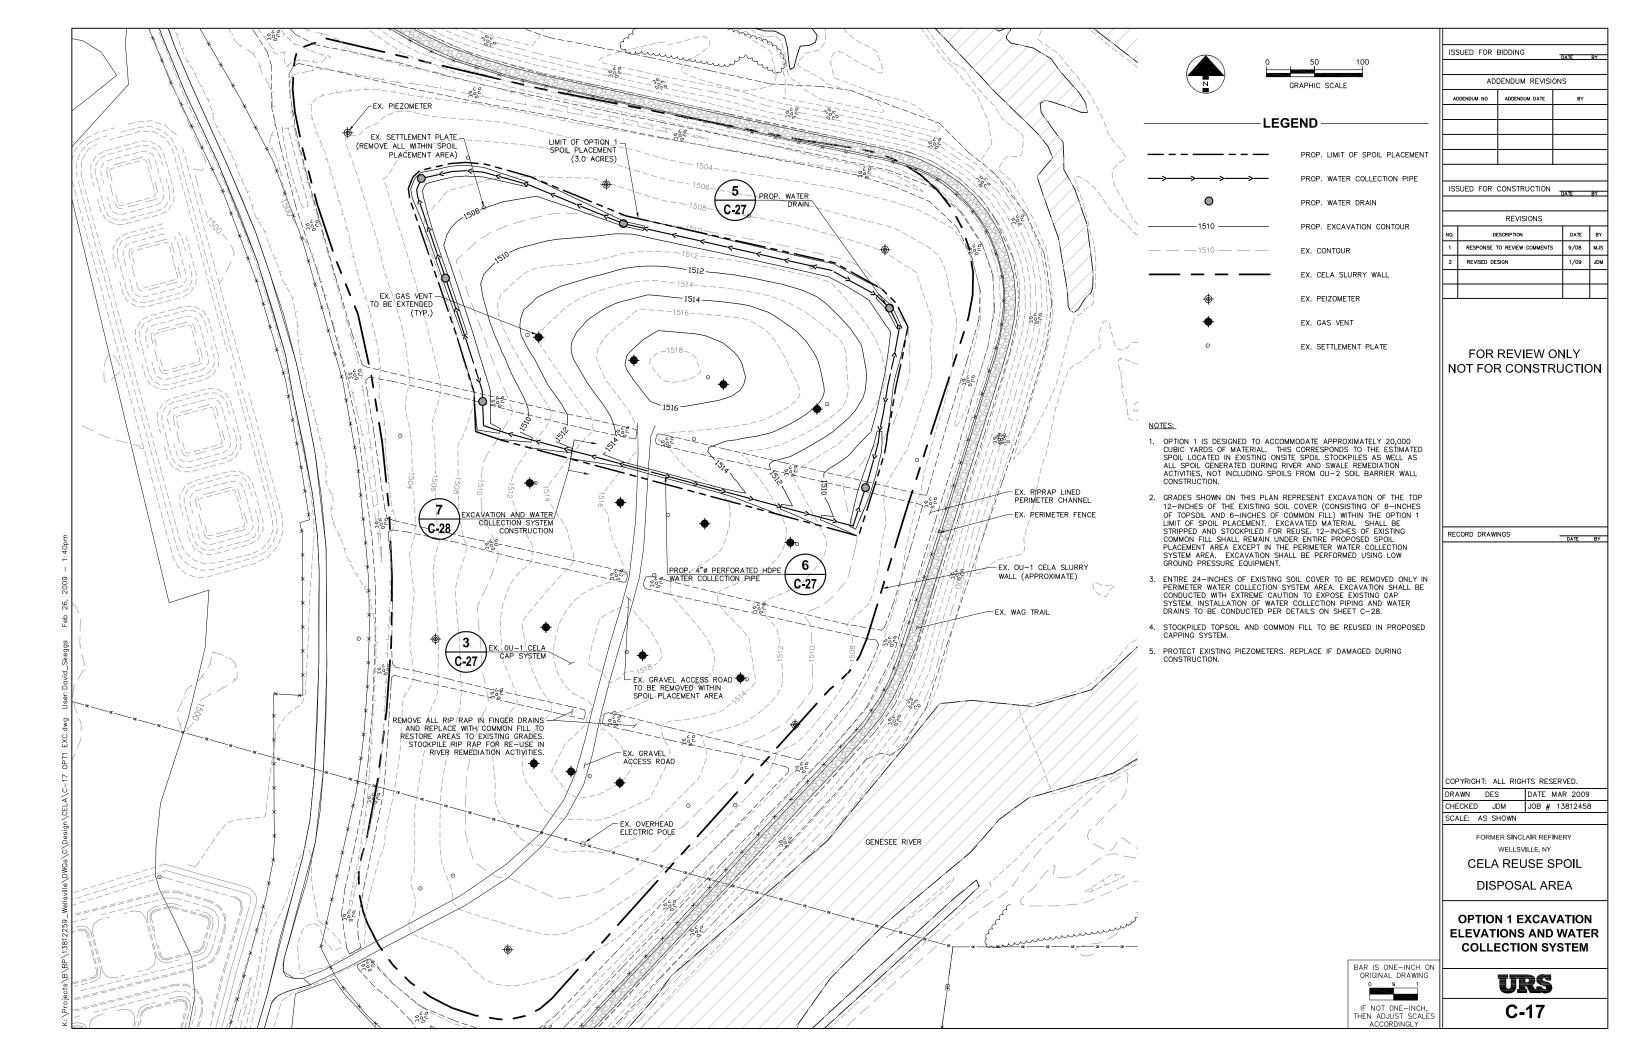

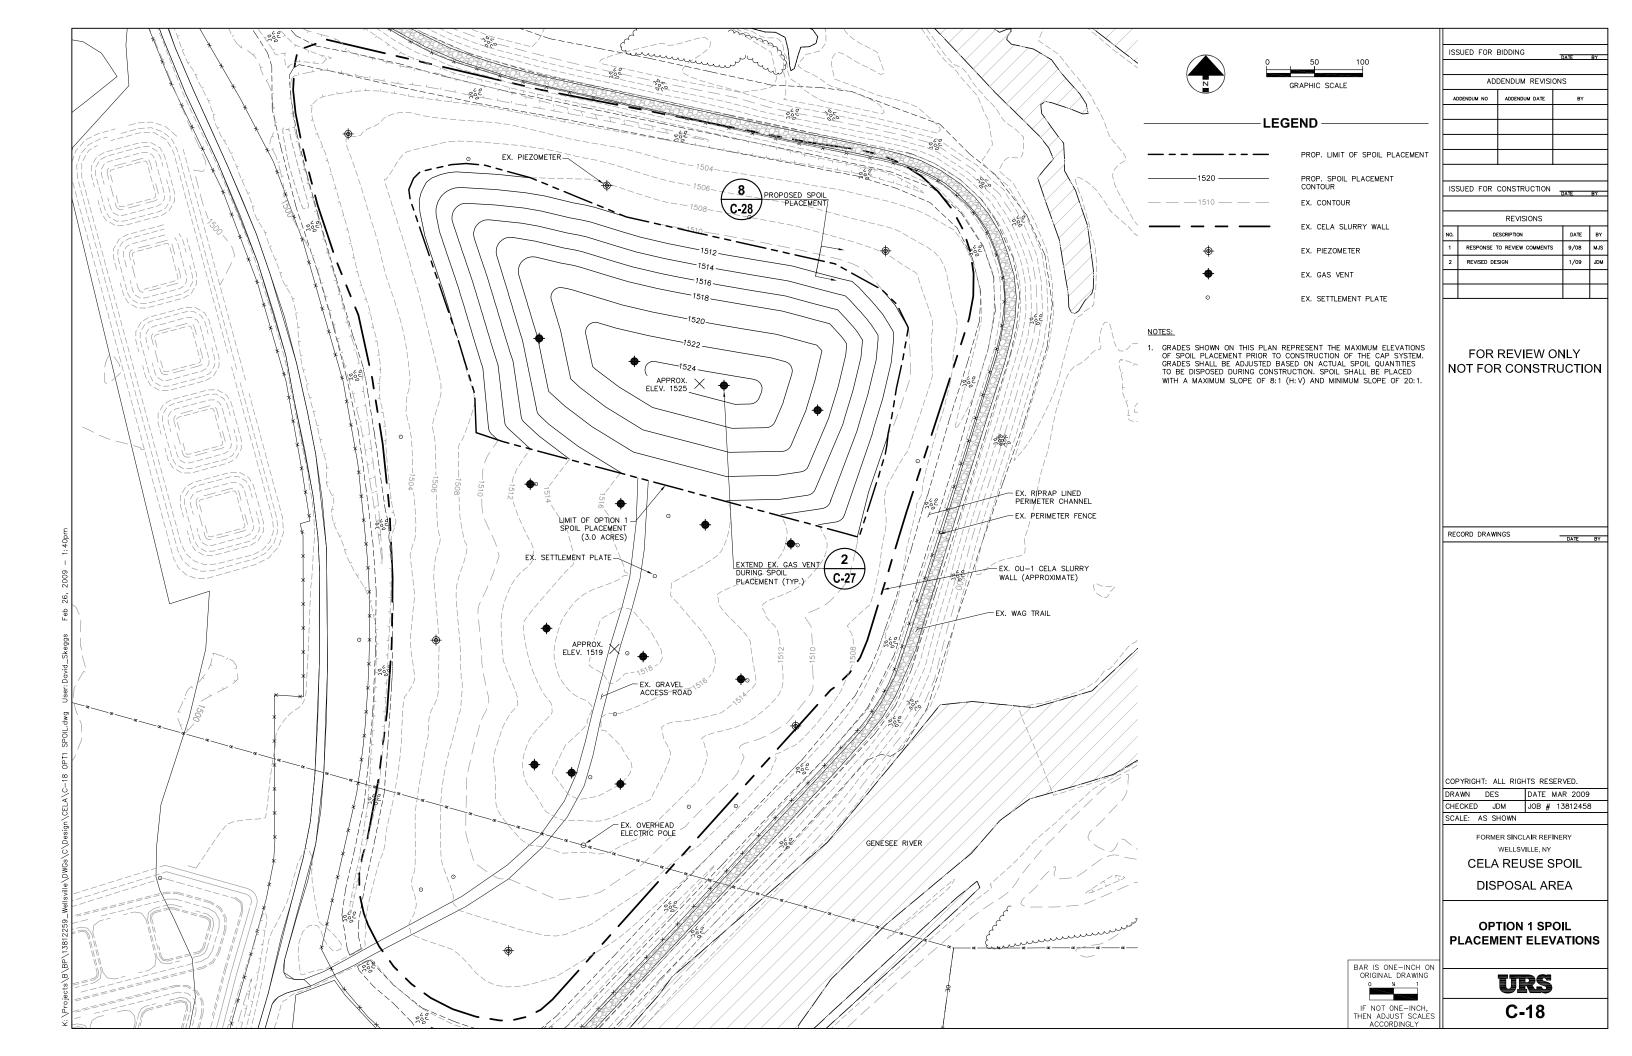

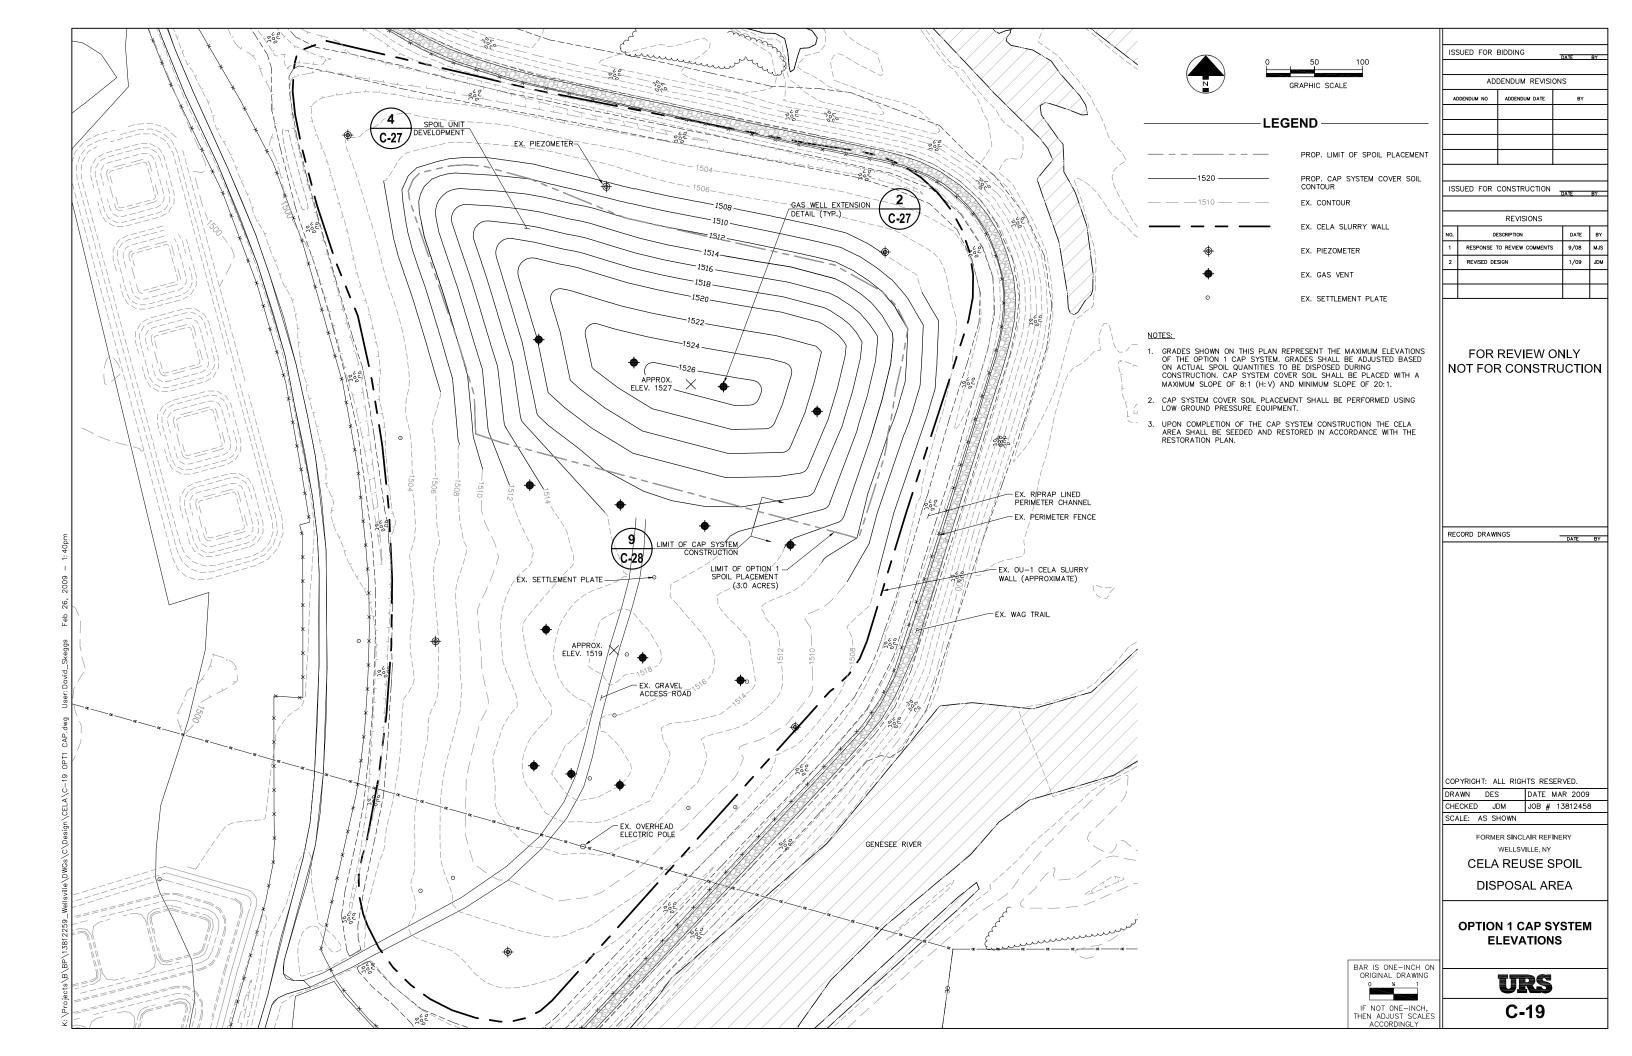


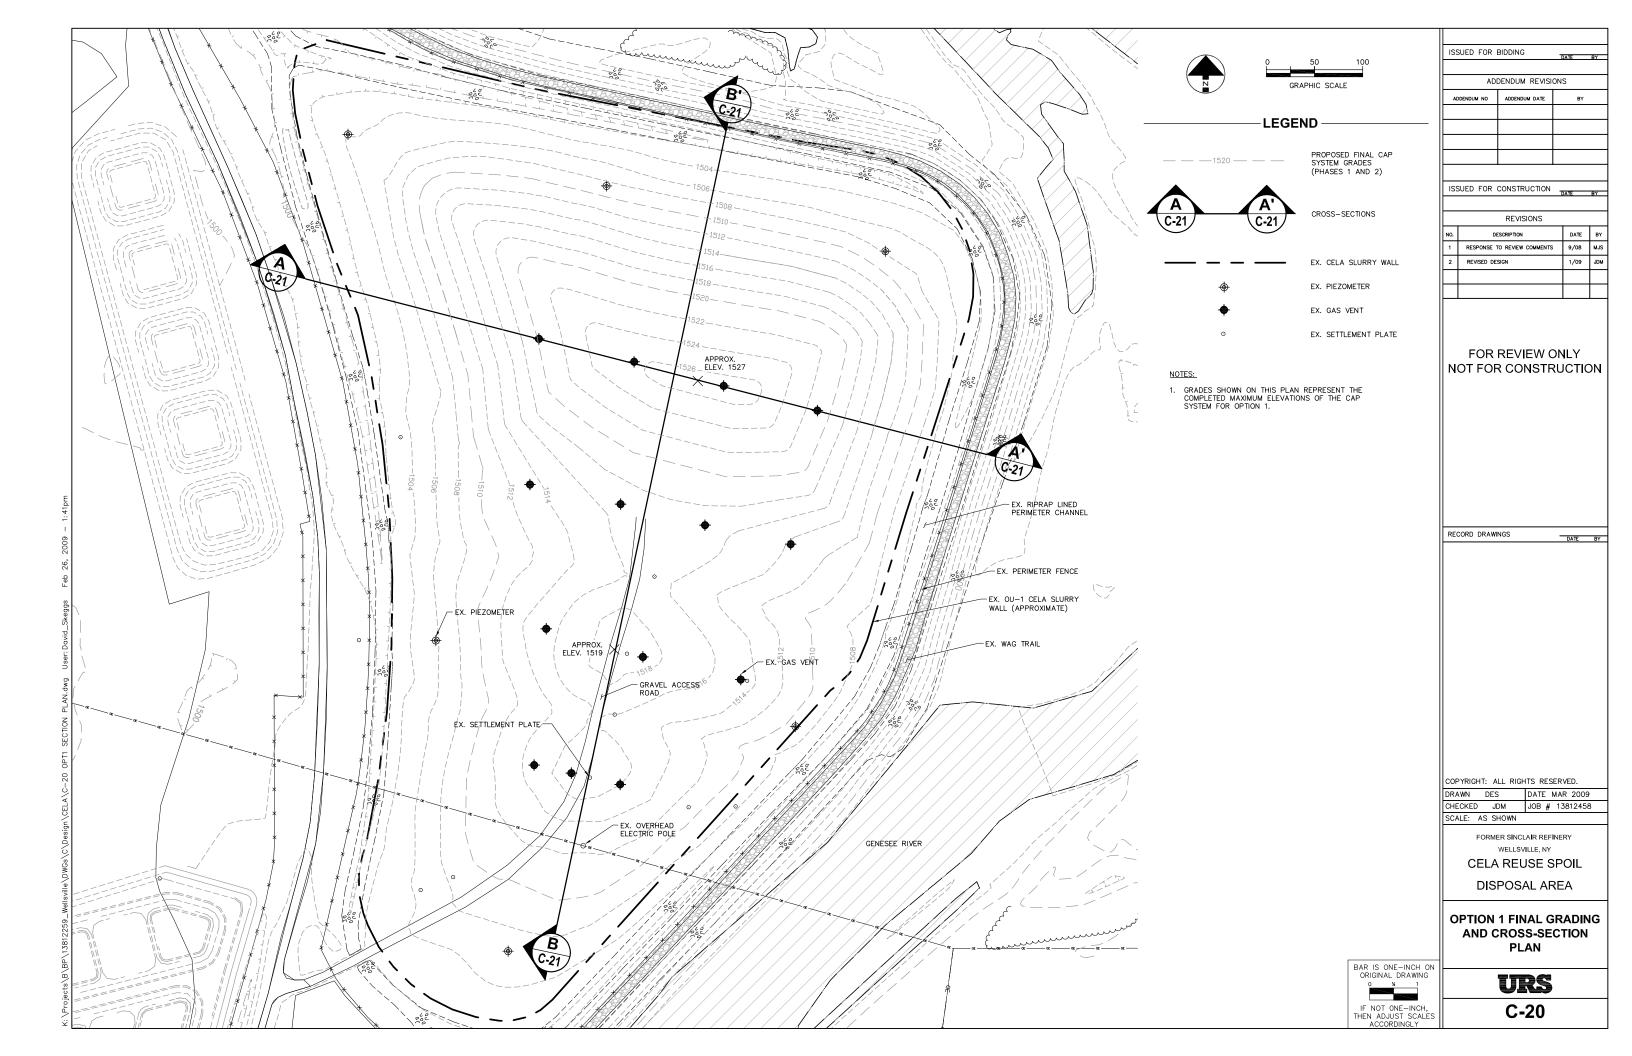


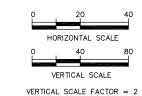

NOTES:

1. CROSS-SECTIONS ARE PROVIDED FOR ILLUSTRATIVE PURPOSES ONLY. REFER TO SHEET C-20 FOR CROSS-SECTION PLAN.

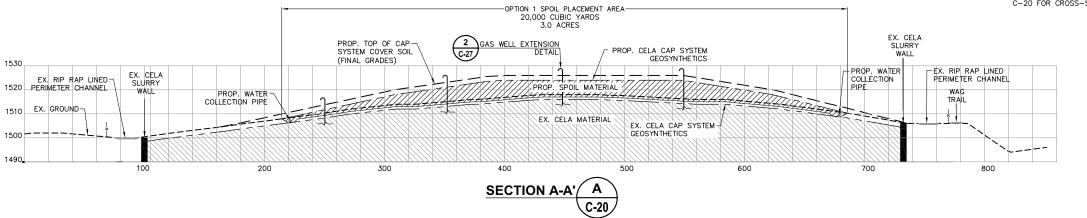

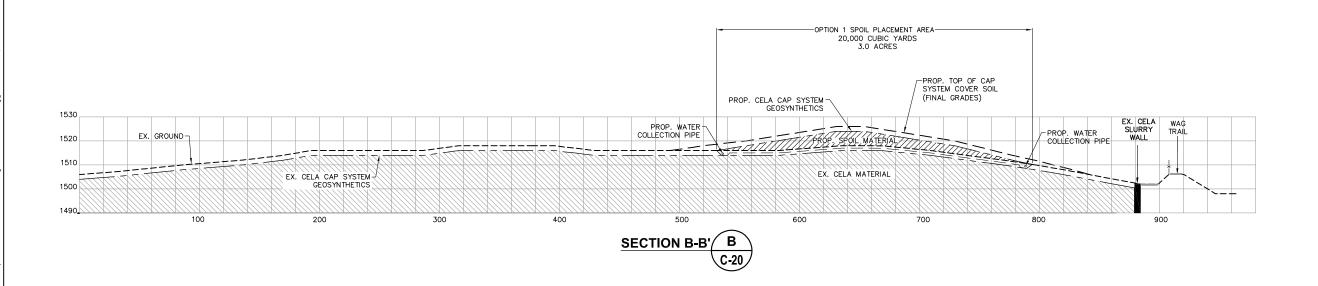

ISSUED FOR BIDDING ADDENDUM REVISIONS

ISSUED FOR CONSTRUCTION DATE

REVISED DESIGN

DATE BY DESCRIPTION RESPONSE TO REVIEW COMMENTS 9/08 MJS

1/09 JDM

DATE BY

FOR REVIEW ONLY NOT FOR CONSTRUCTION

RECORD DRAWINGS

DATE MAR 2009 DRAWN DES CHECKED JDM JOB # 13812458 SCALE: AS SHOWN

COPYRIGHT: ALL RIGHTS RESERVED.

FORMER SINCLAIR REFINERY WELLSVILLE, NY CELA REUSE SPOIL


DISPOSAL AREA


OPTION 1 **CROSS-SECTIONS**


URS


C-21


BAR IS ONE-INCH ON ORIGINAL DRAWING IF NOT ONE-INCH, THEN ADJUST SCALES ACCORDINGLY

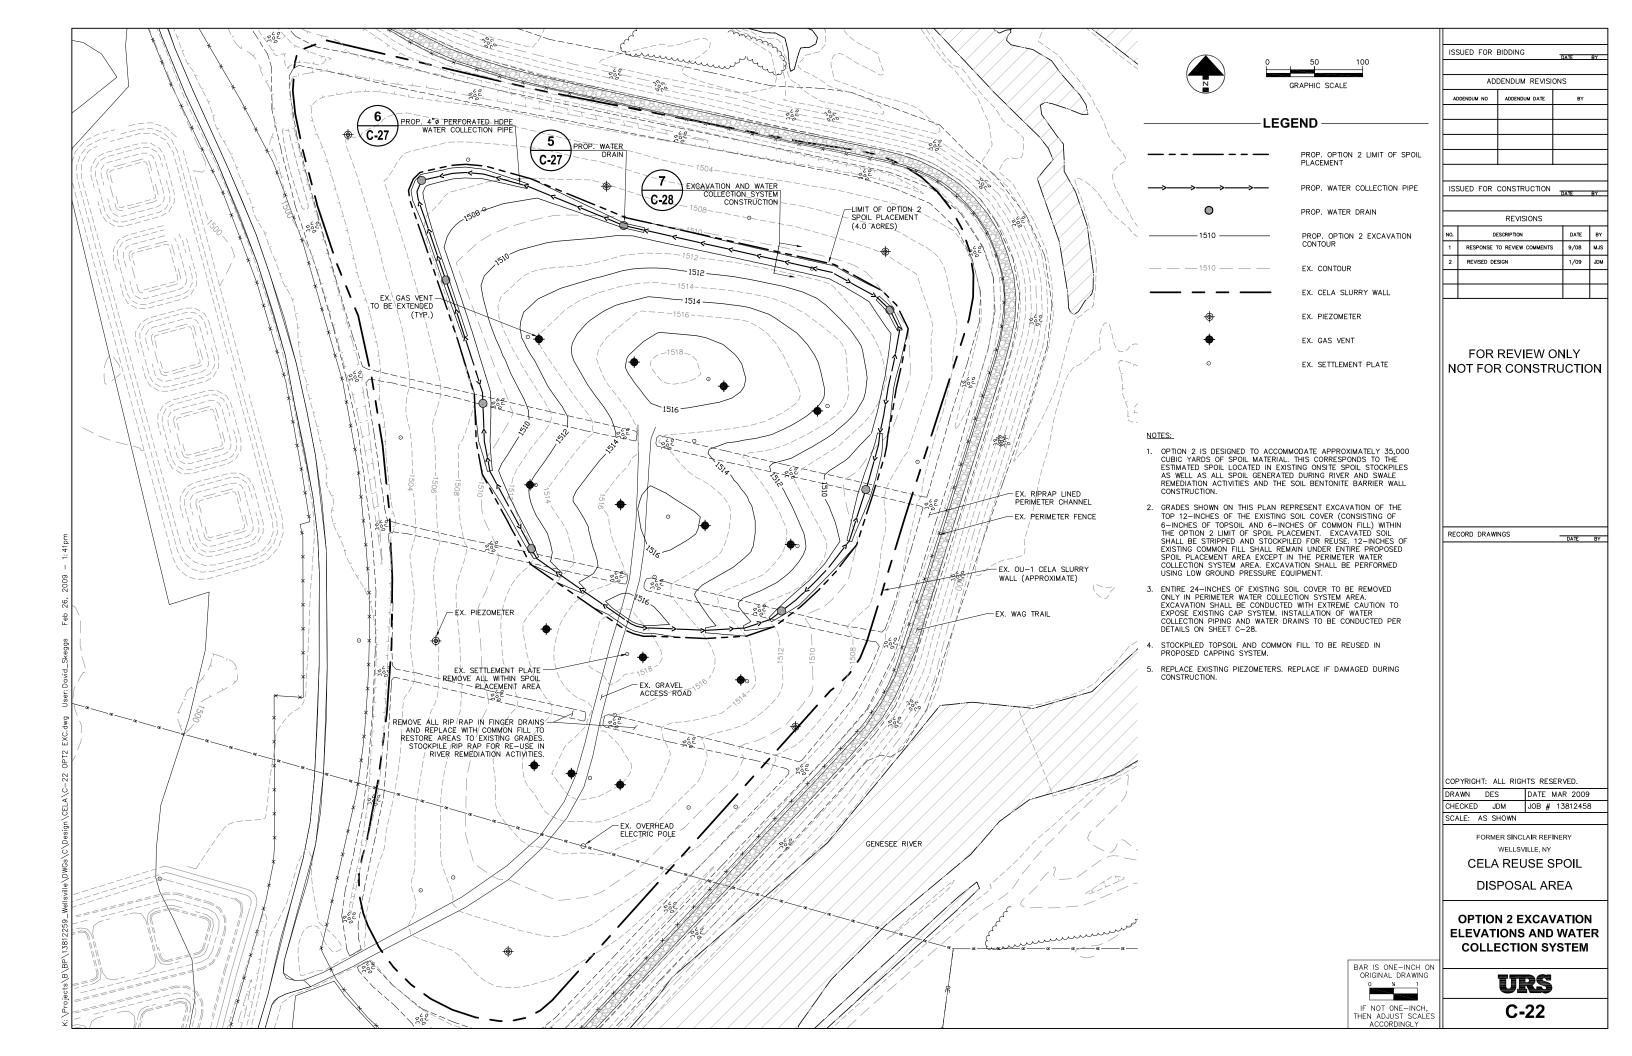

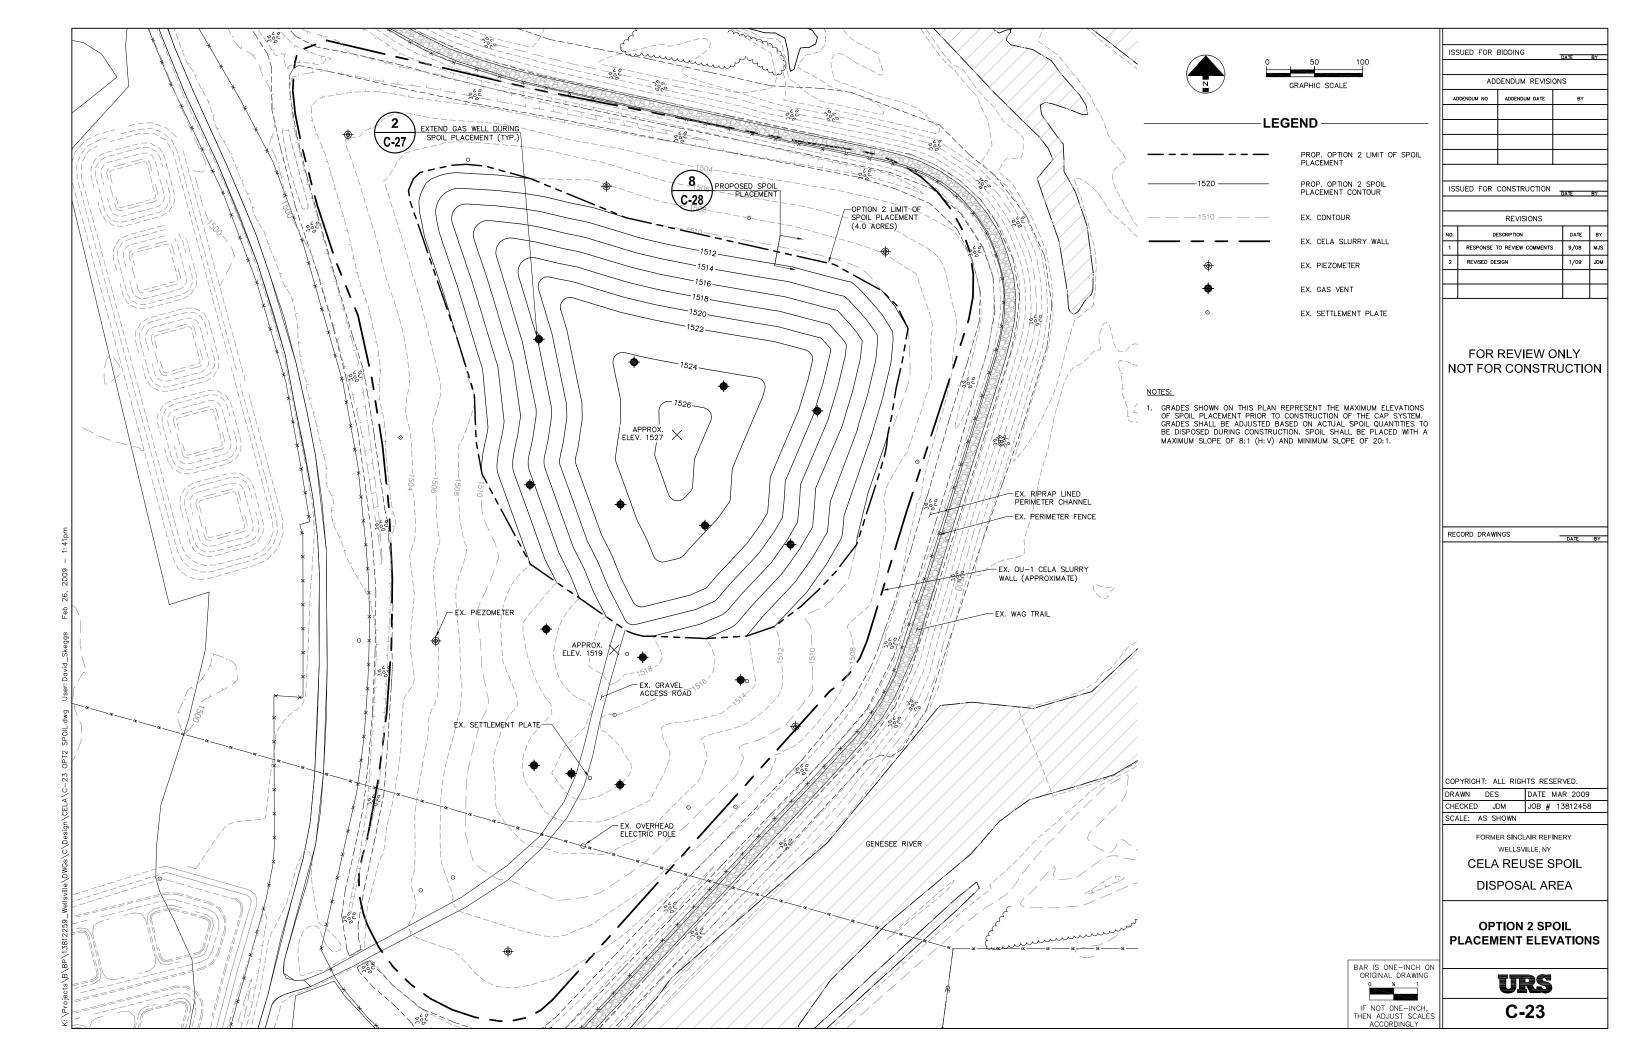

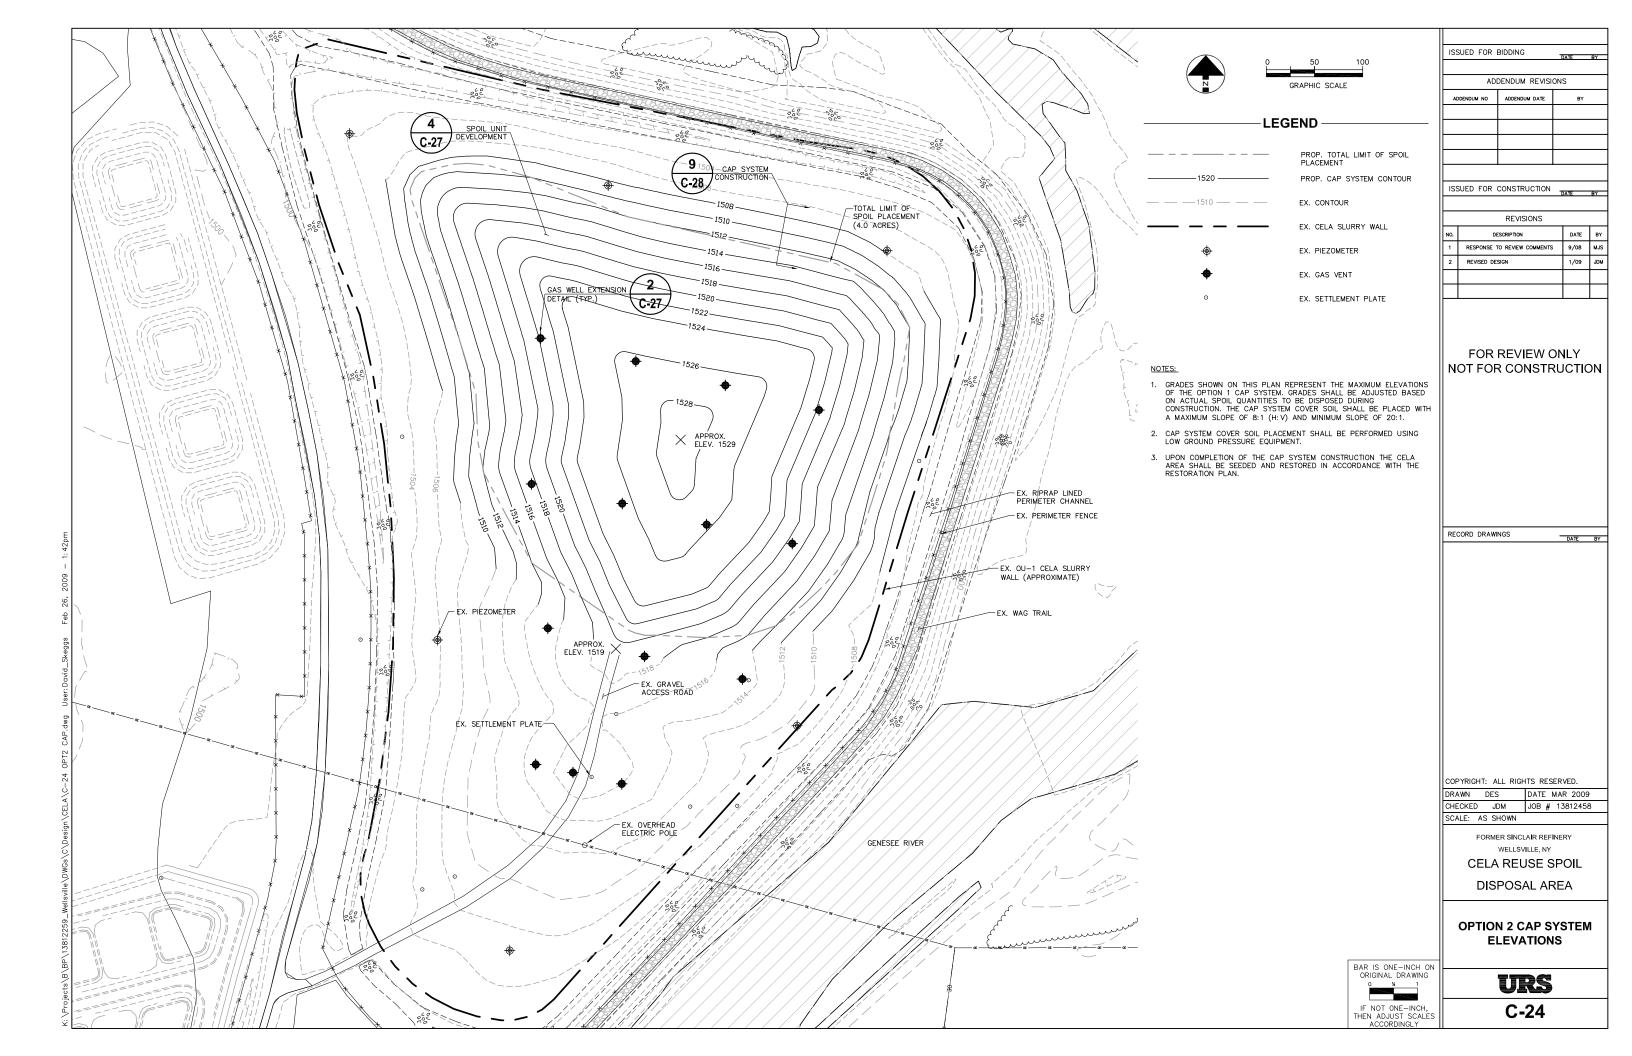

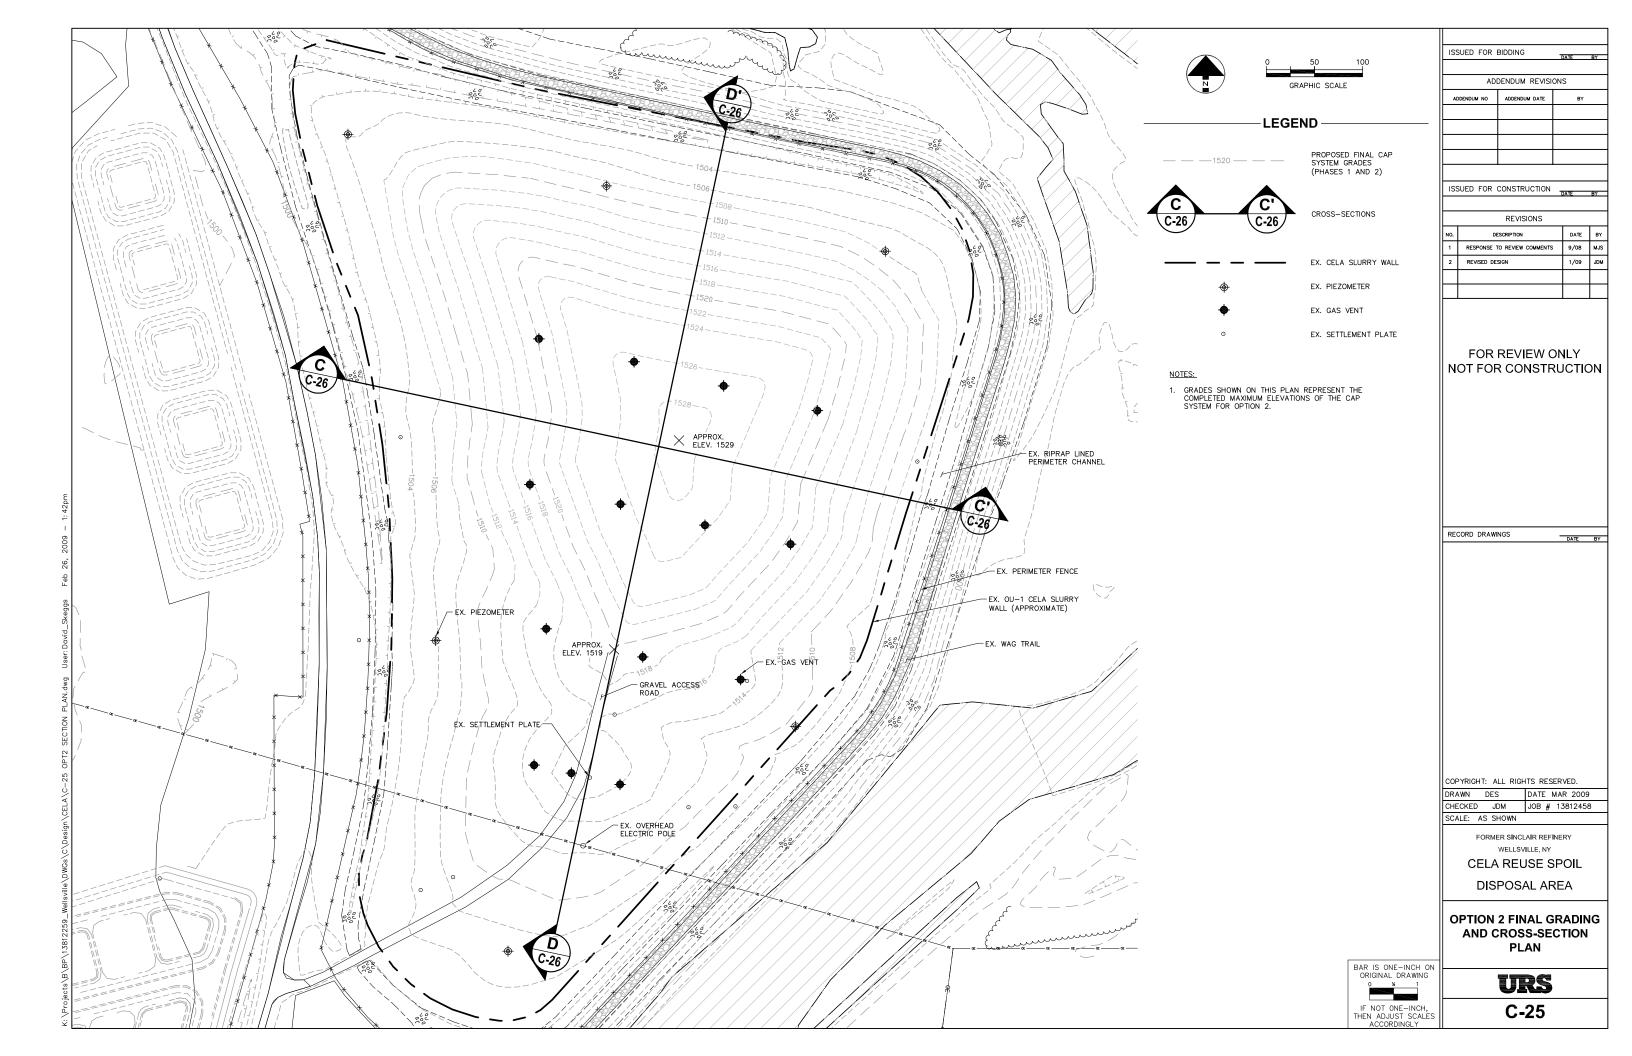

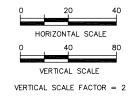

NOTES:

1. CROSS-SECTIONS ARE PROVIDED FOR ILLUSTRATIVE PURPOSES ONLY, REFER TO SHEET C-25 FOR CROSS-SECTION PLAN.

ADDENDUM REVISIONS

ADDENDUM NO ADDENDUM DATE BY

ISSUED FOR CONSTRUCTION DATE

REVISED DESIGN

REVISIONS	
DESCRIPTION	DA
ESPONSE TO REVIEW COMMENTS	9/0

1/09 JDM

DATE BY

FOR REVIEW ONLY NOT FOR CONSTRUCTION

RECORD DRAWINGS

COPYRIGHT: ALL RIGHTS RESERVED.

DRAWN DES DATE MAR 2009

DRAWN DES DATE MAR 2009
CHECKED JDM JOB # 13812458
SCALE: AS SHOWN

FORMER SINCLAIR REFINERY WELLSVILLE, NY


CELA REUSE SPOIL


DISPOSAL AREA

OPTION 2 CROSS-SECTIONS

URS


C-26

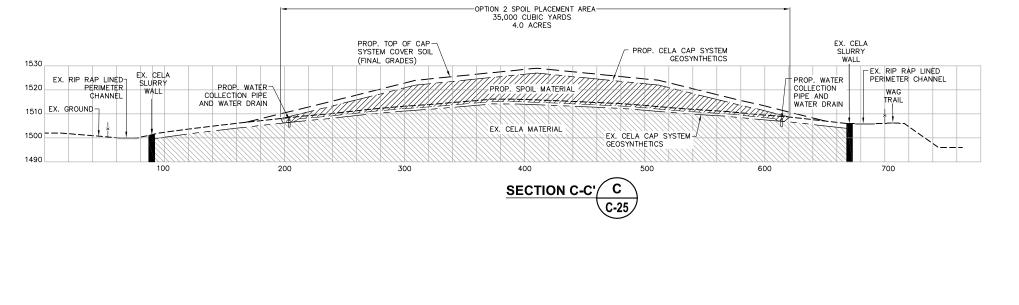

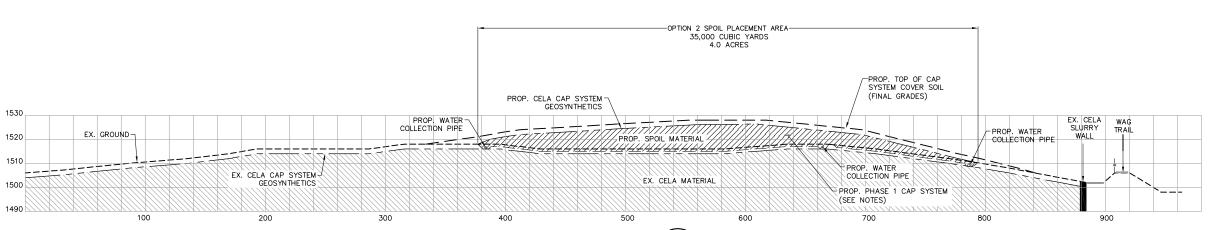

SECTION D-D' D C-25

ts\B\BP\13812259_Wellsville\DWGs\C\Design\CELA\C-26 OPT2 SEC

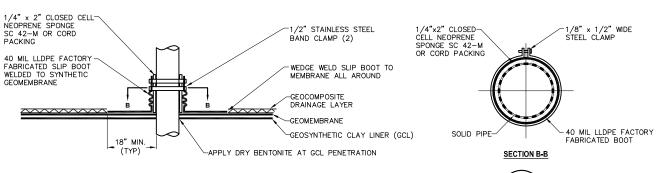

TYPICAL GEOMEMBRANE/PIPE PENETRATION

C-27


EXISTING 8 OZ GEOTEXTILE

-EXISTING 8 OZ GEOTEXTILE


NOT TO SCALE

NOTES:

- 1. DETAIL TYPICAL FOR ALL PENETRATIONS OF CAP GEOMEMBRANE.
- 2. CONTRACTOR MAY SUBMIT ALTERNATE DETAILS AS RECOMMENDED BY THE GEOMEMBRANE MANUFACTURER FOR APPROVAL BY ENGINEER

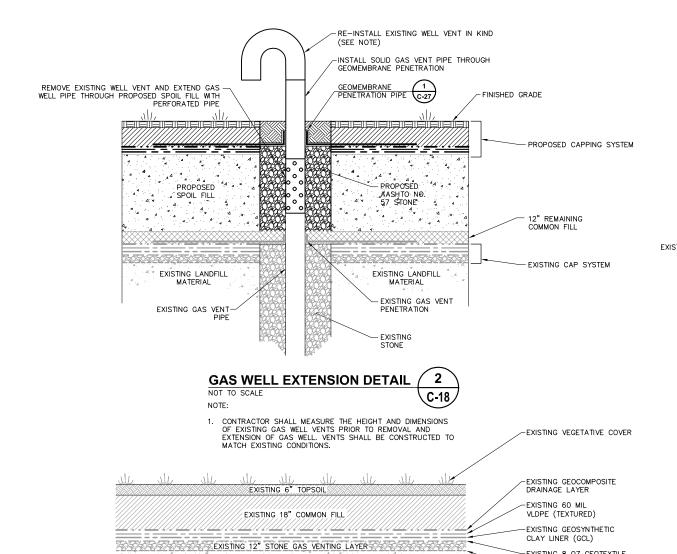


C-17

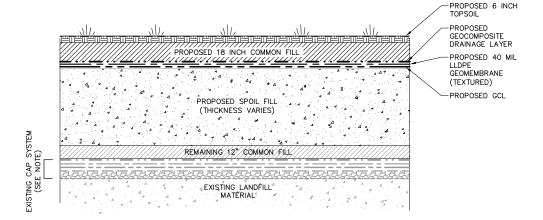


SPOIL UNIT DEVELOPMENT

- 1. THE TOP 12-INCHES OF THE EXISTING SOIL COVER (CONSISTING OF 6-INCHES OF TOPSOIL AND 6-INCHES OF COMMON FILL SHALL BE STRIPPED AND STOCKPILED FOR REUSE.

 12-INCHES OF EXISTING COMMON FILL SHALL REMAIN UNDER ENTIRE PROPOSED SPOIL PLACEMENT AREA EXCEPT IN THE PERIMETER WATER COLLECTION SYSTEM AREA.
- ENTIRE 24-INCHES OF EXISTING SOIL COVER TO BE REMOVED ONLY IN PERIMETER WATER COLLECTION SYSTEM AREA. SEE DETAILS ON SHEET C-28.
- 3. STOCKPILED TOPSOIL AND COMMON FILL TO BE REUSED IN PROPOSED CAPPING SYSTEM.

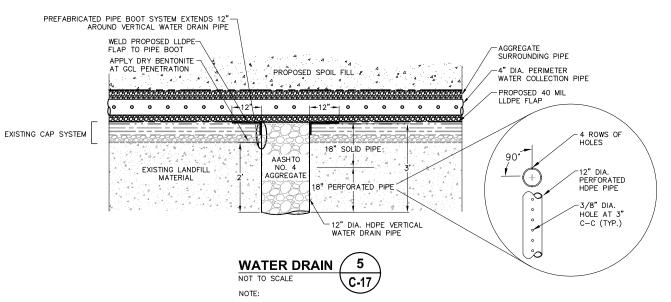

- WATER DRAINS TO BE INSTALLED ALONG PERIMETER WATER DRAIN PIPE AT LOW POINTS AS SHOWN ON PLANS.
- DRY BENTONITE SHALL BE APPLIED AT ALL WATER DRAIN PENETRATIONS TO PROVIDE A SEAL TO EXISTING CAP SYSTEM GCL.

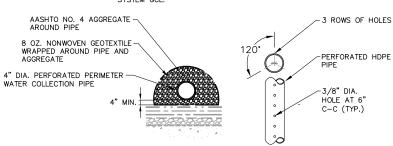

WATER COLLECTION PIPE NOT TO SCALE C-17



ISSUED FOR BIDDING ADDENDUM REVISIONS

ISSUED FOR CONSTRUCTION

DESCRIPTION DATE B 9/08 MJ RESPONSE TO REVIEW COMMENTS REVISED DESIGN 1/09 JDM

FOR REVIEW ONLY NOT FOR CONSTRUCTION

DATE BY

RECORD DRAWINGS

COPYRIGHT: ALL RIGHTS RESERVED.

DATE MAR 2009 DRAWN DES CHECKED JDM JOB # 13812458 SCALE: AS SHOWN

> FORMER SINCLAIR REFINERY WELLSVILLE, NY CELA REUSE SPOIL

DISPOSAL AREA

CONCEPTUAL DETAILS I

URS C-27


EXISTING CAP SYSTEM DETAIL BASED ON INFORMATION PROVIDED IN "REMEDIAL ACTION REPORT CENTRAL ELEVATED LANDFILL AREA". GEOSYNTEC CONSULTANTS, DECEMBER 1993.

EXISTING LANDFILL MATERIAL

EXISTING CAP SYSTEM

EXCAVATION AND WATER COLLECTION SYSTEM CONSTRUCTION


1. ALL EXCAVATION ON THE EXISTING CELA CAP SYSTEM SHALL BE PERFORMED USING LOW GROUND PRESSURE EQUIPMENT OR BY HAND

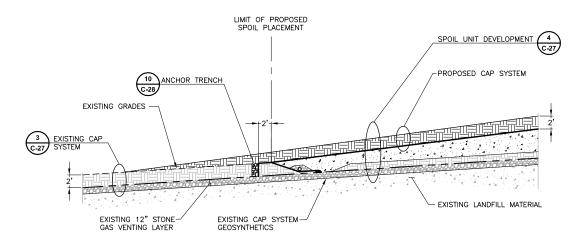

LIMIT OF CAP SYSTEM CONSTRUCTION C-19

9


1. CAP SYSTEM COVER SOIL SHALL BE PLACED USING LOW GROUND PRESSURE EQUIPMENT.

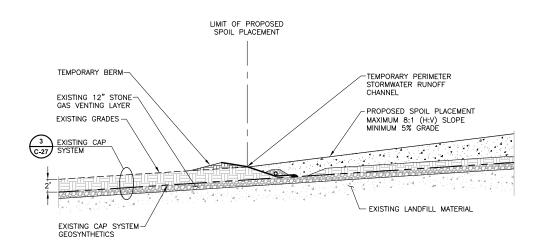

PROPOSED SPOIL PLACEMENT NOT TO SCALE

SEQUENCE OF CAP SYSTEM AND ANCHOR TRENCH CONSTRUCTION

- FOLD BACK GEOMEMBRANE FLAP AND REMOVE TEMPORARY BERM. EXCAVATE ANCHOR TRENCH APPROXIMATELY 2 FEET BEYOND LIMIT OF SPOIL PLACEMENT. EXCAVATE ANCHOR TRENCH TO EXISTING LINER SYSTEM GEOSYNTHETICS (TOP OF EXISTING GEOCOMPOSITE DRAINAGE LAYER).
 PLACE 40 MIL LLDPE MEMBRANE FLAP IN TRENCH.
- . PLACE 40 MIL LLUPE MEMBHARNE FLAP IN INENCH.
 INSTALL PROPOSED CAP SYSTEM GEOSYNTHETICS, TERMINATING
 GEOSYNTHETICS IN ANCHOR TRENCH.
 BACKFILL ANCHOR TRENCH WITH AGGREGATE MATERIAL.
 PLACE CAP SYSTEM COVER SOIL.

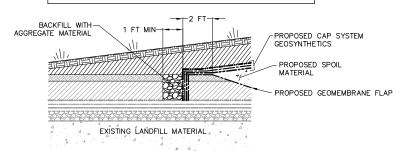

ANCHOR TRENCH DETAIL 10 NOT TO SCALE C-28 NOTE:

1. CAP SYSTEM COVER SOIL SHALL BE PLACED USING LOW GROUND PRESSURE EQUIPMENT.

ISSUED FOR BIDDING ADDENDUM REVISIONS

ISSUED FOR CONSTRUCTION

DESCRIPTION DATE B RESPONSE TO REVIEW COMMENTS 9/08 MJS REVISED DESIGN 1/09 JDM

FOR REVIEW ONLY NOT FOR CONSTRUCTION

DATE BY

RECORD DRAWINGS

COPYRIGHT: ALL RIGHTS RESERVED.

DRAWN DES DATE MAR 2009 CHECKED JDM JOB # 13812458 SCALE: AS SHOWN

> FORMER SINCLAIR REFINERY WELLSVILLE, NY CELA REUSE SPOIL

DISPOSAL AREA

CONCEPTUAL DETAILS II

BAR IS ONE-INCH ON ORIGINAL DRAWING IF NOT ONE-INCH THEN ADJUST SCALES

URS C-28