


Figure 1: Table of Anticipated Permits/Approvals


Below is a table showing anticipated agency approval types and the estimated length of the approval process. Please note: additional approvals not shown in this table may be required.


Agency	Approval / Permit Type	Estimated Length of Approval Process
New York State Department of Environmental Conservation (NYSDEC)	Tidal Wetlands permit	1 - 2 years
New York State Department of Environmental Conservation (NYSDEC)	SPDES Permit for Construction Activities and Post-Construction Stormwater Managmeent	60 days
New York State Department of Environmental Conservation (NYSDEC)	Coastal Erosion Hazard Area Permit	6 months
US Army Corp of Engineers (USACoE)	Applicable permits for work in/near Newtown Creek	1 - 2 years
New York State Department of State (NYSDOS)	State Coastal Consistency Analysis	45 days
NYC Department of City Planning (NYCDCP)	WRP Consistency Analysis	45 days
New York City Department of Environmental Protection (NYCDEP)	Drainage master plan, site connection, private sewer, internal water main, hydrant installation	1 - 2 year (longest lead)
New York City Fire Department (FDNY)	Site access approval (including placement of hydrants)	6 months – 1 year
Metropolitan Transportation Authority – Long Island Railroad (MTA-LIRR)	Applicable permits for work near LIRR	3 - 6 months (non- invasive work)
New York City Department of Parks and Recreation (NYCDPR) and Department of City Planning (NYCDCP)	Applicable permits to satisfy Parks Department and City Planning (zoning) requirements	6 months – 1 year
New York City Department of Buildings (NYCDOB)	Applicable new building permits and filings	3 – 6 months (permitting)
New York City Office of Environmental Remediation (OER)	E-Designation Notice to Proceed	6 months

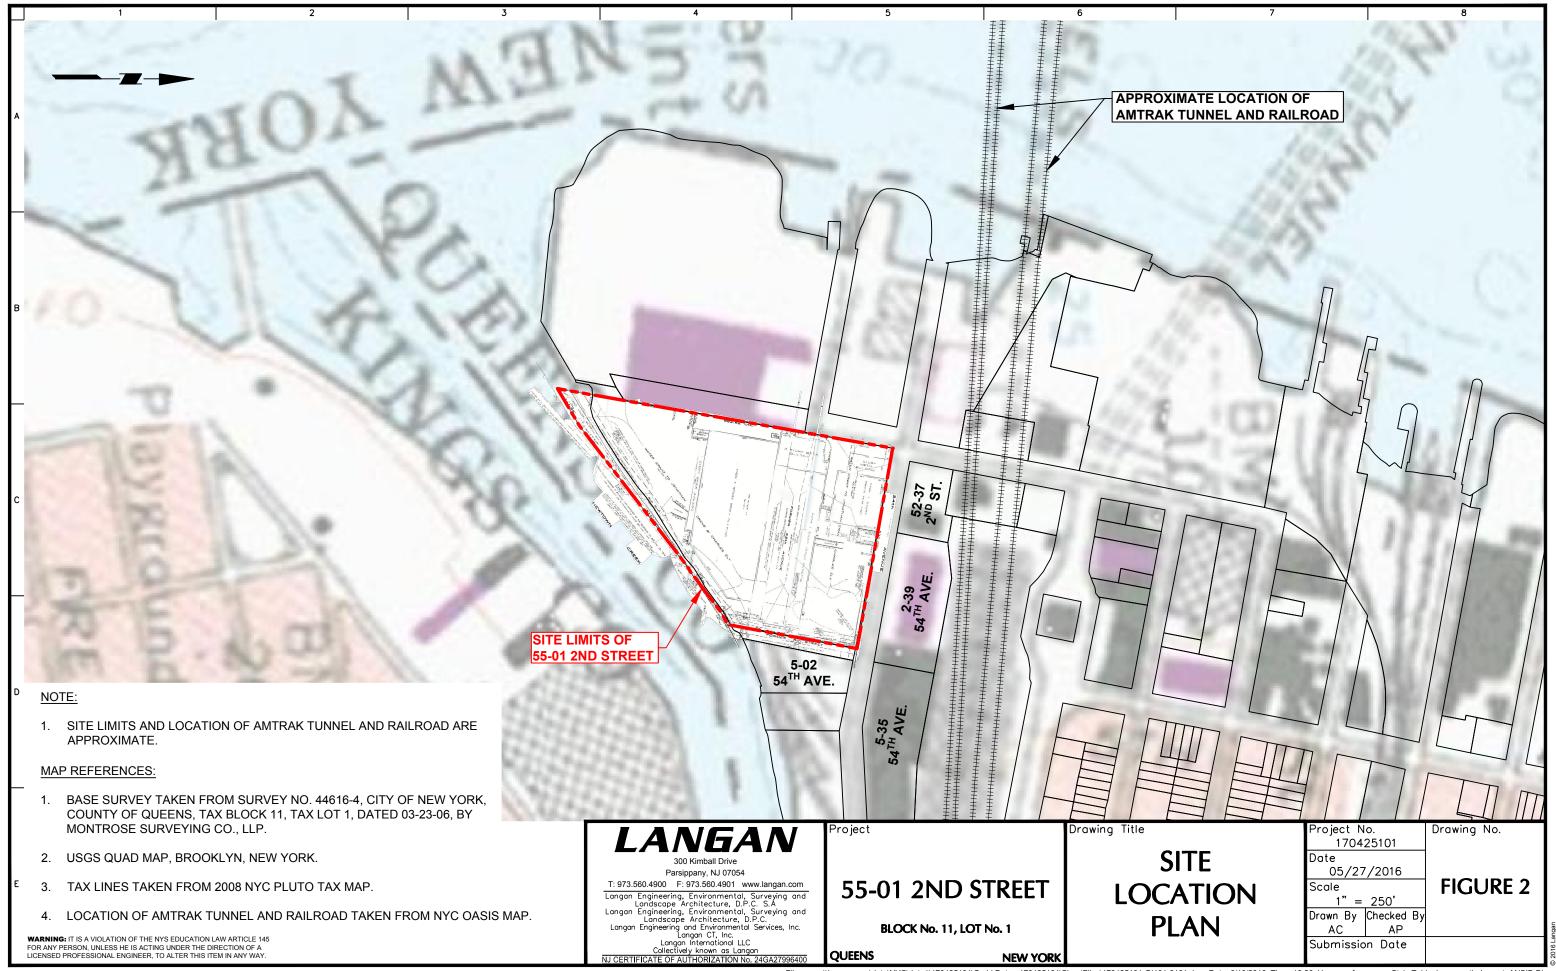


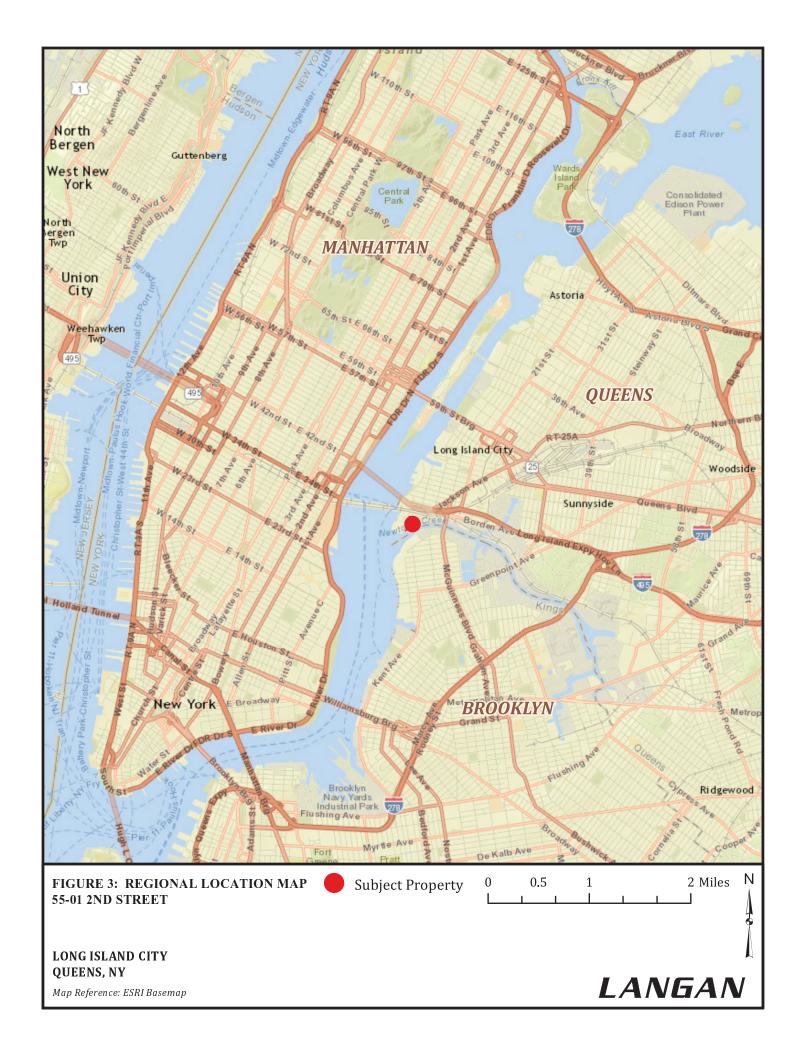


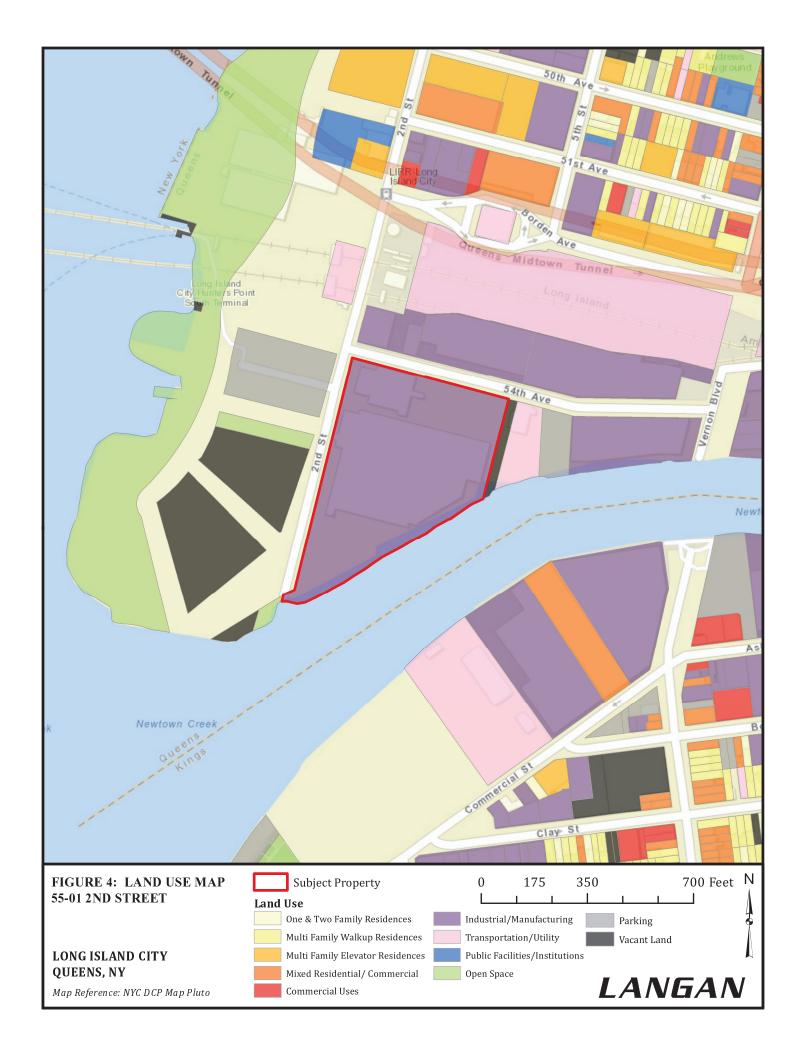

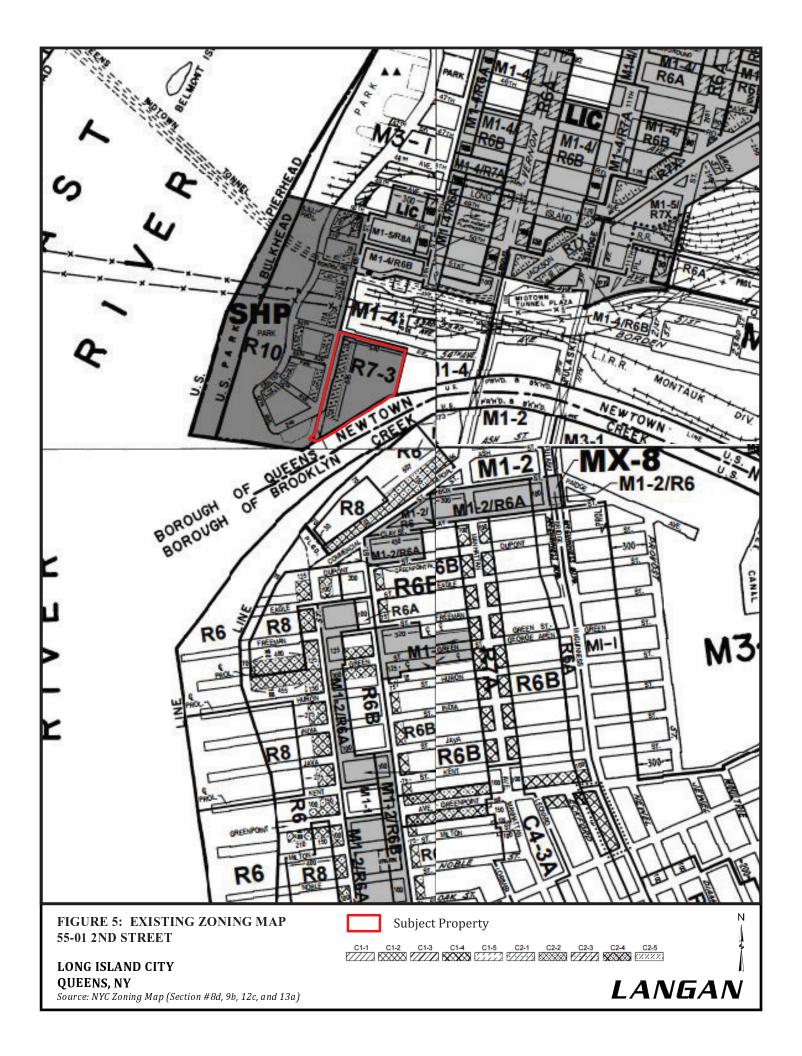

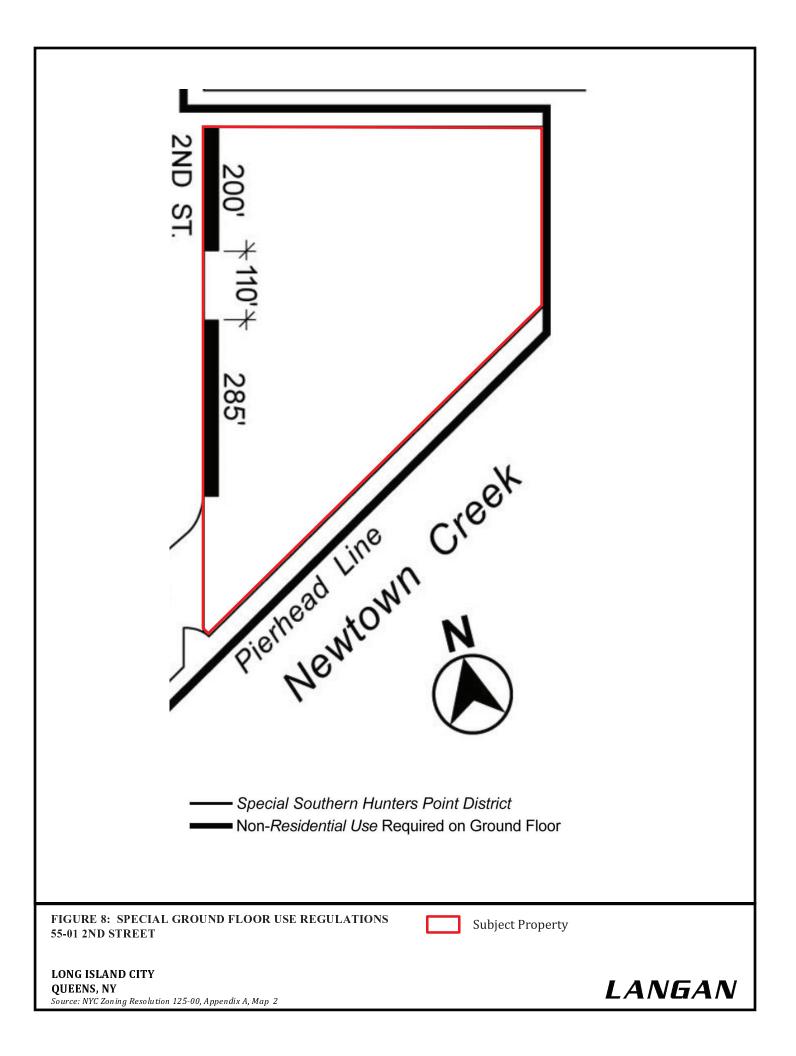

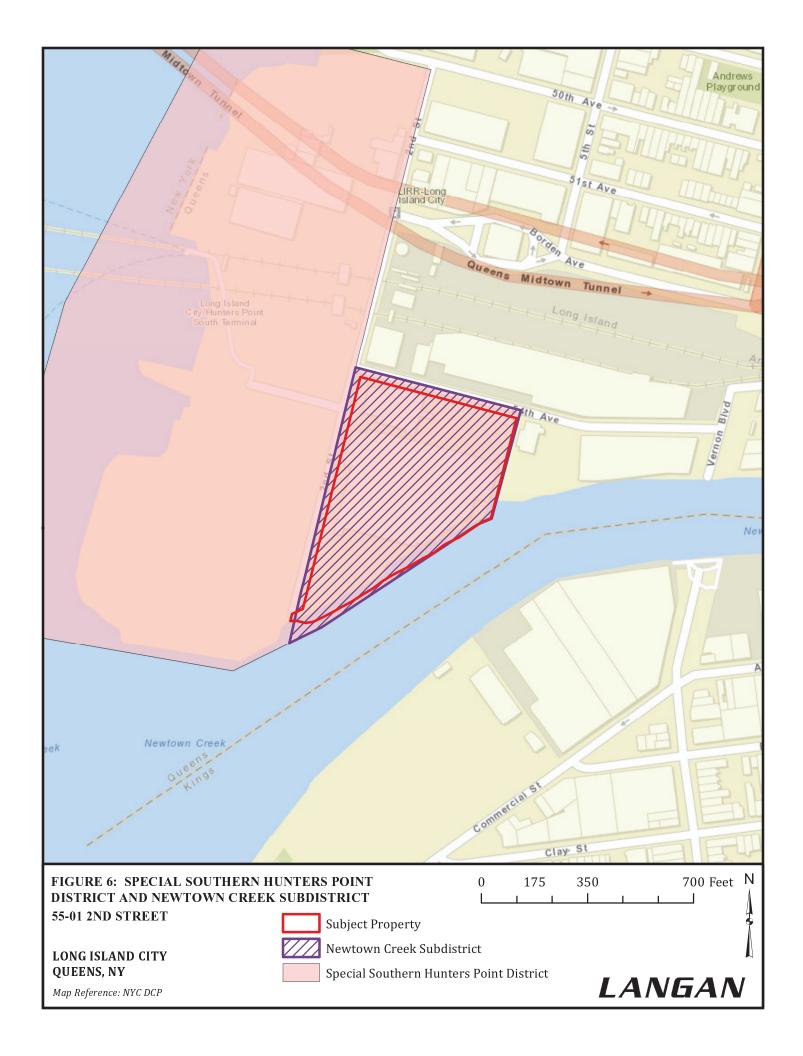

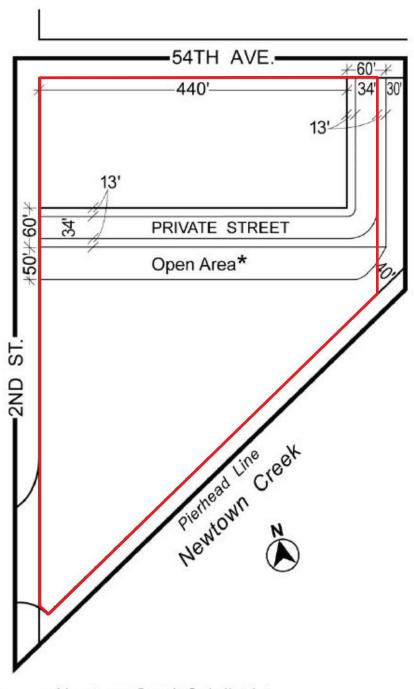

Newtown Creek Subdistrict


FIGURE 7: PUBLICLY ACCESSIBLE PRIVATE STREET AND OPEN AREA IN NEWTOWN CREEK SUBDISTRICT 55-01 2ND STREET


Subject Property


LONG ISLAND CITY QUEENS, NY


**LANGAN** 


<sup>\*</sup>One 13' wide walkway connecting sidewalk of private street and residential building entrance may traverse Open Area beyond 200' of 2nd St.

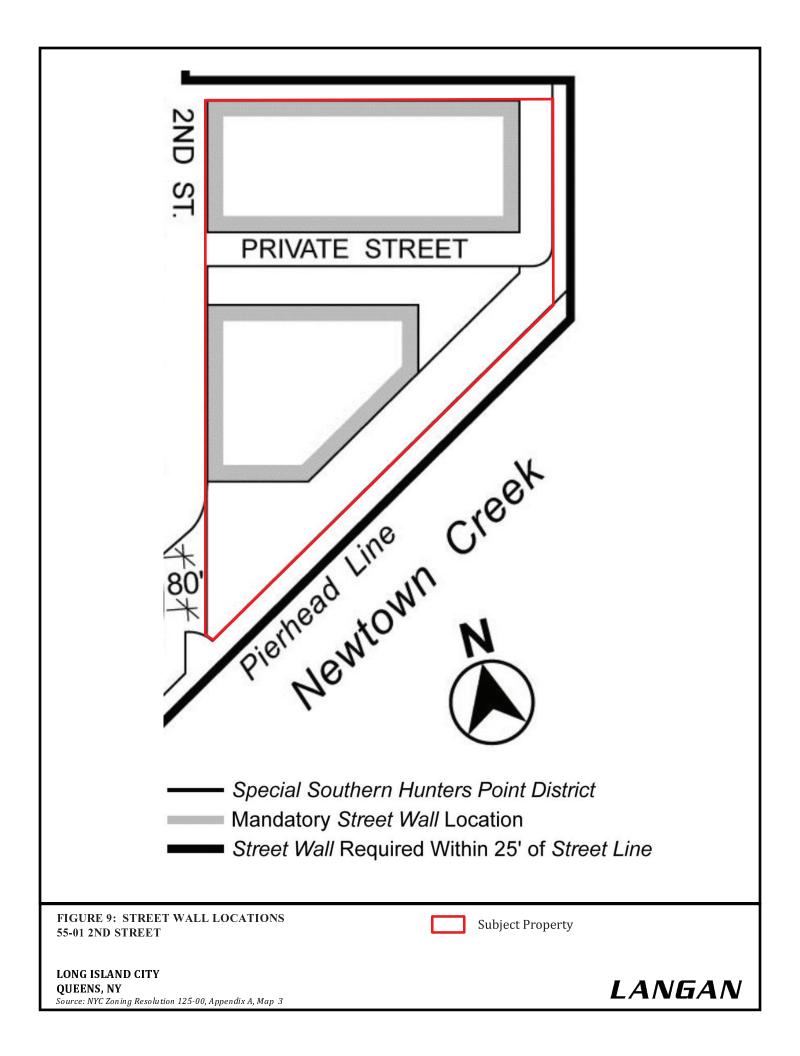


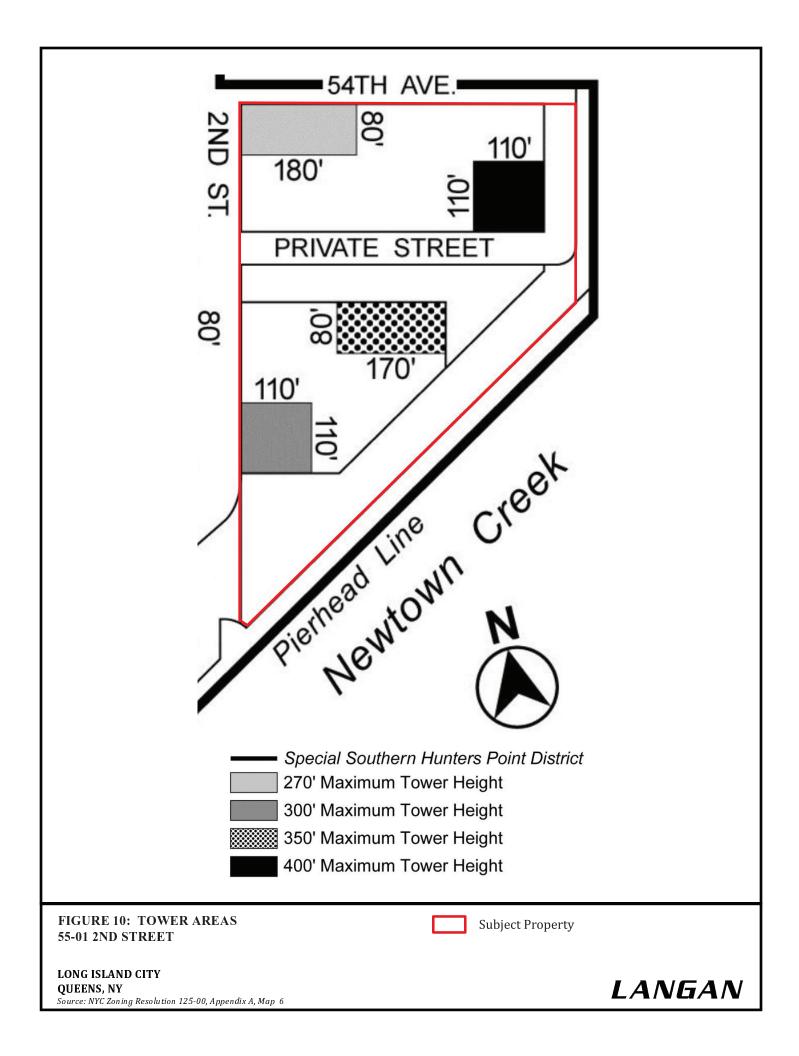

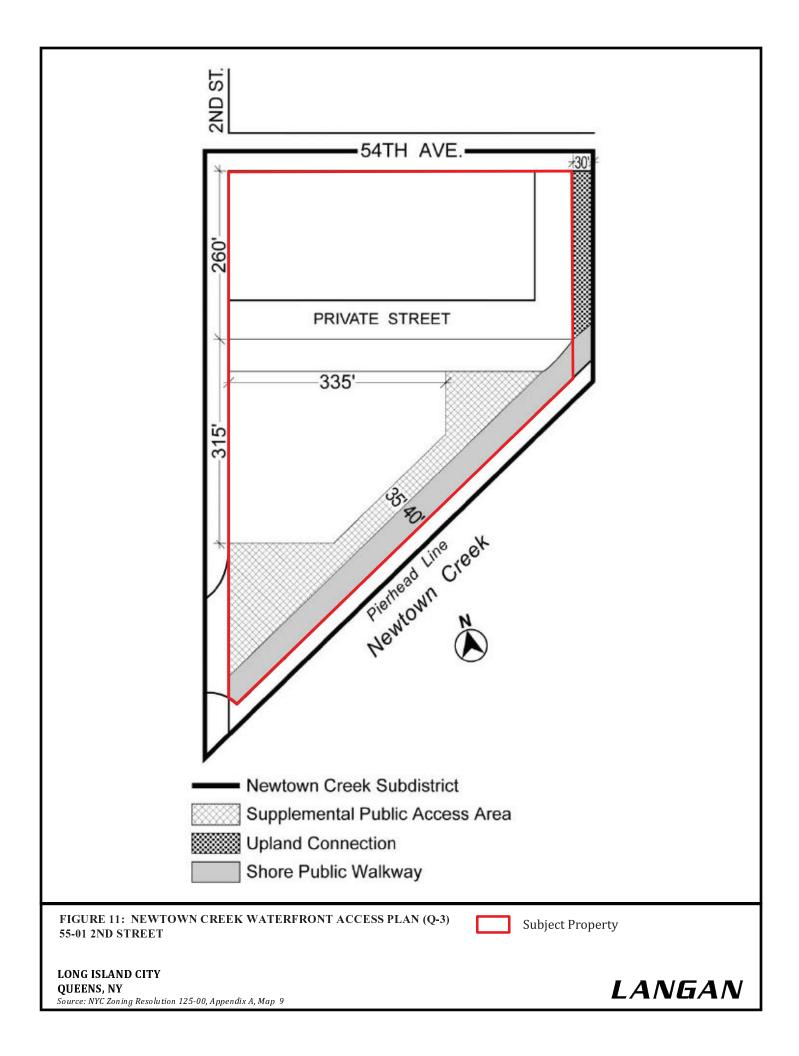

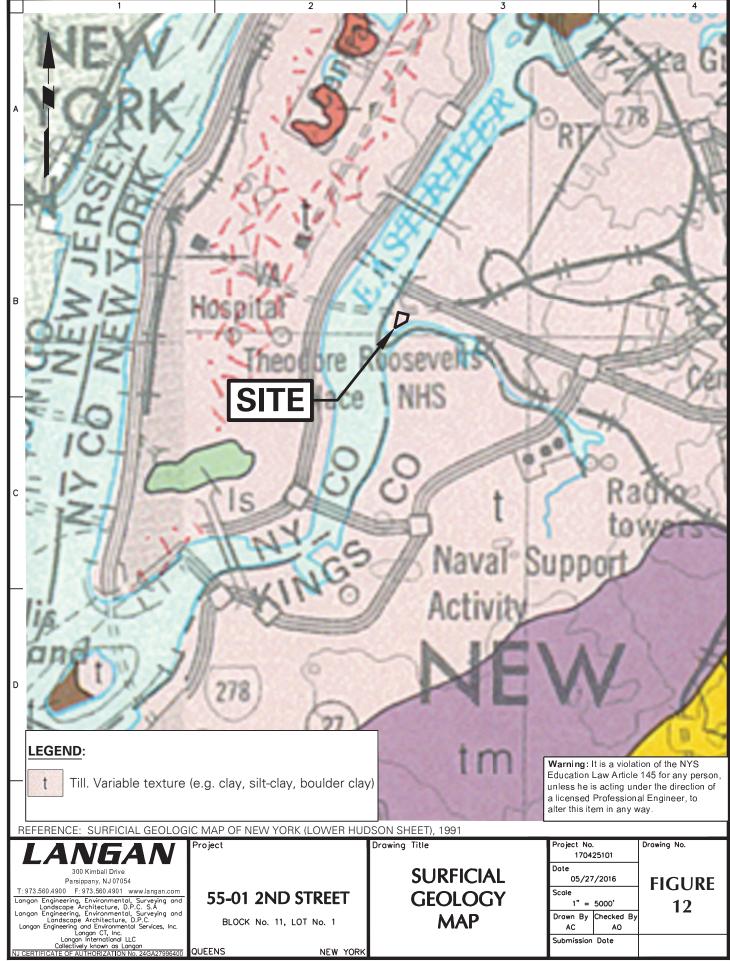

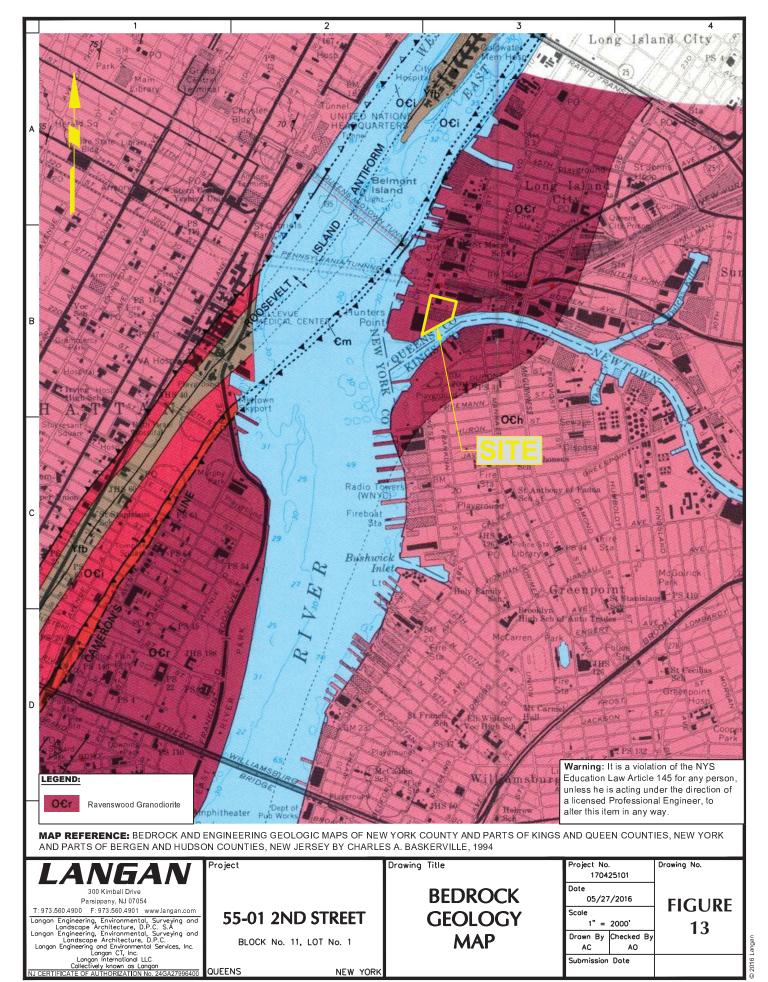

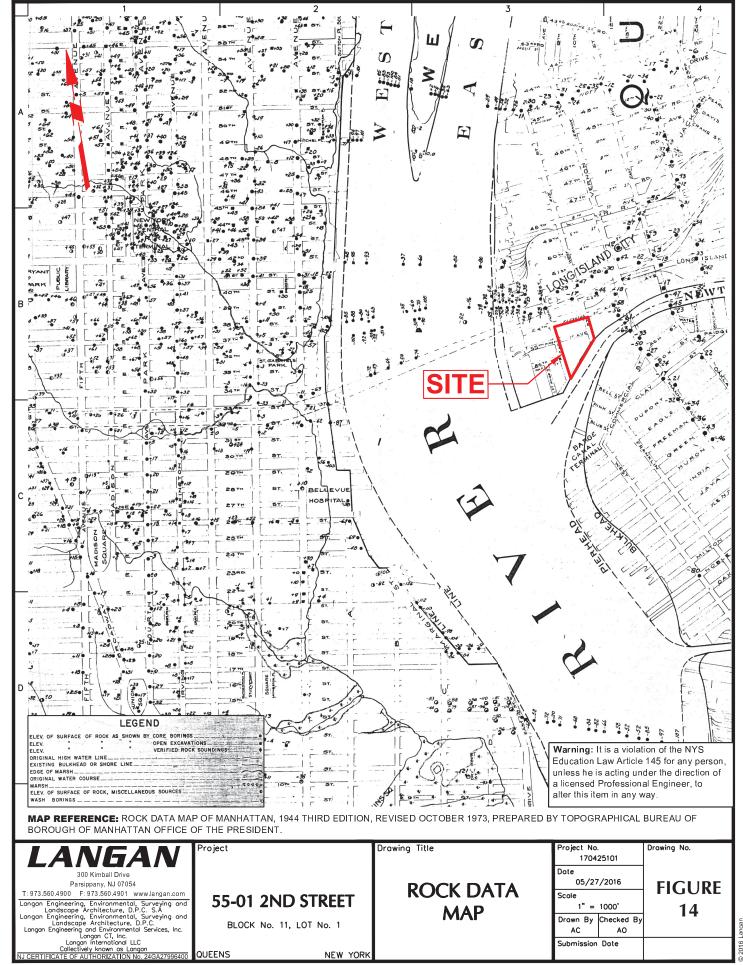



## **LEGEND**

APPROXIMATE SITE LOCATION

APPROXIMATE BUILDING LOCATIONS

FORMER LOCATION OF TWO 4,000-GALLON USTs

APPROXIMATE LOADING DOCK LOCATION

SOIL SAMPLE LOCATION (AES 2006)

SOIL AND GROUNDWATER SAMPLE LOCATION (AES 2006)

SOIL AND GROUNDWATER SAMPLE LOCATION (AKRF 2013)

## NOTES:

- BASE MAP TAKEN FROM AUTODESK AUTOCAD CIVIL 3D AEREAL MAP ON MAY 18, 2016.
- 2. THE FORMER UST AREA LOCATION AND SIZE ARE APPROXIMATE.
- 3. BORING LOCATIONS ARE APPROXIMATE. BORING LOCATIONS ARE REFERENCED FROM FIGURE 2 (SITE PLAN WITH SAMPLING LOCATIONS) OF THE SUBSURFACE (PHASE II) INVESTIGATION REPORT PREPARED BY AKRF AND DATED NOVEMBER 2013.
- 4. AES (ASSOCIATED ENVIRONMENTAL SERVICES, LTD.)
  PERFORMED AN ENVIRONMENTAL SUBSURFACE
  INVESTIGATION THAT INCLUDED THE COLLECTION OF SOIL
  AND GROUNDWATER SAMPLES IN FEBRUARY 2006.
- 5. AKRF PERFORMED AN ENVIRONMENTAL SUBSURFACE INVESTIGATION THAT INCLUDED THE COLLECTION OF SOIL AND GROUNDWATER SAMPLES IN OCTOBER 2013.

**WARNING:** IT IS A VIOLATION OF THE NYS EDUCATION LAW ARTICLE 145 FOR ANY PERSON, UNLESS HE IS ACTING UNDER THE DIRECTION OF A LICENSED PROFESSIONAL ENGINEER, TO ALTER THIS ITEM IN ANY WAY.



## ANGAN

21 Penn Plaza, 360 West 31st Street, 8th Floor New York, NY 10001

T: 212.479.5400 F: 212.479.5444 www.langan.com Langan Engineering, Environmental, Surveying and Landscape Architecture, D.P.C. S.A. Langan Engineering, Environmental, Surveying and Landscape Architecture, D.P.C.

Langan Engineering and Environmental Services, Inc. Langan CT, Inc. Langan International LLC Collectively known as Langan

Project

**55-01 2ND STREET** 

BLOCK No. 11, LOT No. 1 LONG ISLAND CITY QUEENS **NEW YORK**  Figure Title

**BORING LOCATION PLAN** 

170425101 Date 05/18/2016 Scale

Figure No. **FIGURE** 15

1"=150' Drawn By Checked By MLR JDL Submission Date

Project No.

Sheet XX of XX

Filename: \\langan.com\data\\Y\data1\170425101\Cadd Data - 170425101\2D-DesignFiles\Figure 1 - Site Plan.dwg Date: 5/26/2016 Time: 12:39 User: mrogers Style Table: Langan.stb Layout: ANSIB-BL

## FEMA New York City Preliminary FIRM Data Viewer

