

November 25, 2025

Brad Demo
Environmental Program Specialist 1
New York State Department of Environmental Conservation
700 Delaware Avenue
Buffalo, New York 14209

Re: New Concrete Plant – Additional Work 229 Homer Street (NYSDEC Site No. C905044)

Olean, New York

Dear Mr. Demo:

On behalf of Jamestown Macadam, Inc., Roux Environmental Engineering and Geology, D.P.C. (Roux), has prepared this letter to notify the New York State Department of Environmental Conservation (NYSDEC) of additional intrusive activities planned for the 229 Homer Street Site (NYSDEC Site No. C905044) associated with the new concrete plant. A Notification Addendum to Excavation Work Plan (EWP) was submitted by Roux to the NYSDEC and was subsequently approved on June 16, 2025. The additional work, as described below, will be conducted in accordance with the approved EWP.

Excavation Activities

As indicated on the attached updated Site Plan Drawing C-101, the following additional work is planned for the Site:

- One National Grid power pole will be installed in the northwest portion of the Site. The 45-foot, Class 3 power poles will be installed per the National Grid Clean Corridor Pole Set attached.
- Underground electric utilities and two utility poles will be installed. Electric services are associated with the existing building, block heaters, and fuel tanks.
- Underground water utilities will be installed. Water services are associated with two frost-free hose bib risers.
- A 30-foot by 60-foot pre-engineered metal building to house the 160-ton aggregate batcher.
 Typical cross sections for the piers and walls are attached.
- · A new concrete pad south of the existing building.

During intrusive activities, Roux will provide oversight as well as two monitoring stations, one upwind and one downwind, adjusted on a daily or more frequent basis based on actual wind directions.

Reporting

This additional intrusive work will be included in both the Construction Closeout Report (CCR) and the Site Management Plan (SMP) update.

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Sincerely,

ROUX ENVIRONMENTAL ENGINEERING AND GEOLOGY, D.P.C.

Lori E. Riker, P.E. Principal Engineer

Att.

ec: Adam Hoisington (JMI)

Jacob Hardy (Benson Construction)

Jess Dombrowski (Roux)



STOP-CALL BEFORE YOU DIG!

NEW YORK STATE LAW REQUIRES TWO WORKING DAYS NOTICE BUT NOT MORE THAN 10 WORKING DAYS **UDig NY CALL: 811**

AT LEAST TWO DAYS BEFORE BUT NOT MORE THAN 10 DAYS BEFORE ANY EXCAVATION, ETC., THE CONTRACTOR SHALL CALL/NOTIFY UDIG NY.

THE CONTRACTOR SHALL BE SOLELY RESPONSIBLE FOR ALL EXCAVATION WORK.

"UDIG NY" STANDARD COLOR CODES USED TO INDICATE TYPE OF **UNDERGROUND UTILITY:**

YELLOW: GAS, OIL, PETROLEUM PRODUCTS, COMPRESSED GASES, AND ALL OTHER HAZARDOUS LIQUIDS

RED: ELECTRIC POWER LINES AND/OR CONDUIT.

WHITE: PROPOSED EXCAVATION

(FOR EXCAVATOR). ORANGE: COMMUNICATION LINES AND/OR CABLES, INC. TELEPHONE, TELEGRAPH,

AND CABLE TELEVISION.


BLUE: WATER.


GREEN: STORM AND SANITARY SEWERS INCLUDING FORCE MAINS.

BACKFILL W/ ONSITE -MATERIAL, PLACED IN 8" MAX. LOOSE LIFTS, MECHANICALLY TAMPED INTO PLACE GROUND SURFACE VARIES -CONTRACTOR TO VERIFY EXISTING CONDITIONS IN FIELD AND REPLACE TO


MATCH EXISTING EXCAVATION -WALLS SLOPES OR SHORING TO COMPLY WITH 29 CFR PART 1926

RIBON TYPICAL TRENCH DETAIL FOR DOMESTIC WATER LINES SCALE: N.T.S.

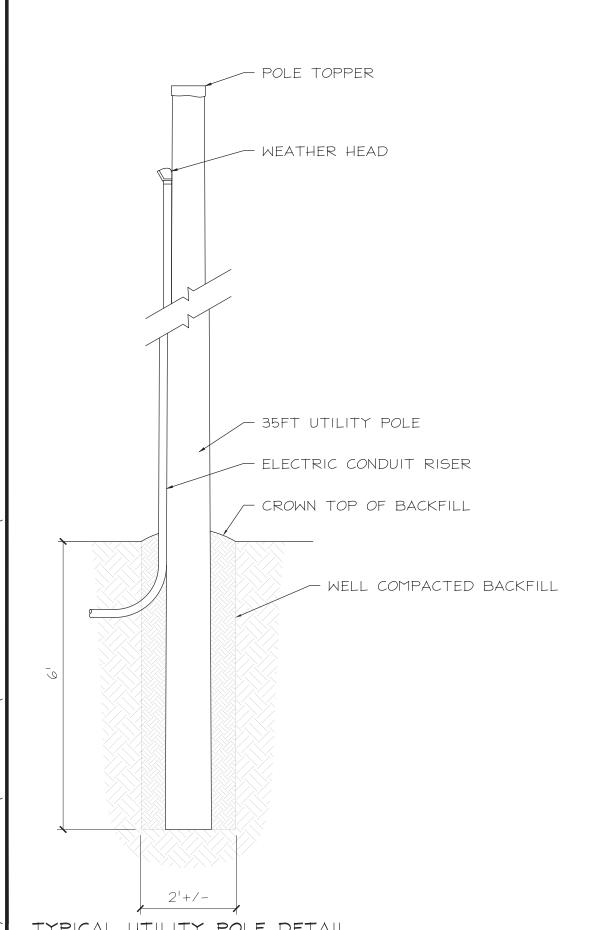

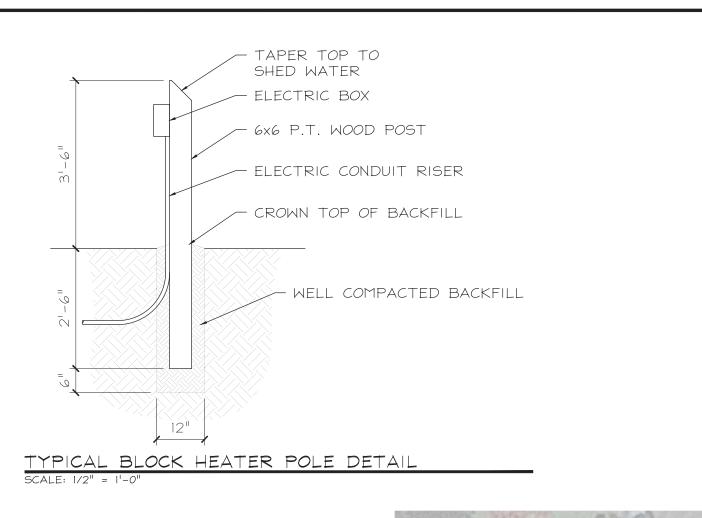



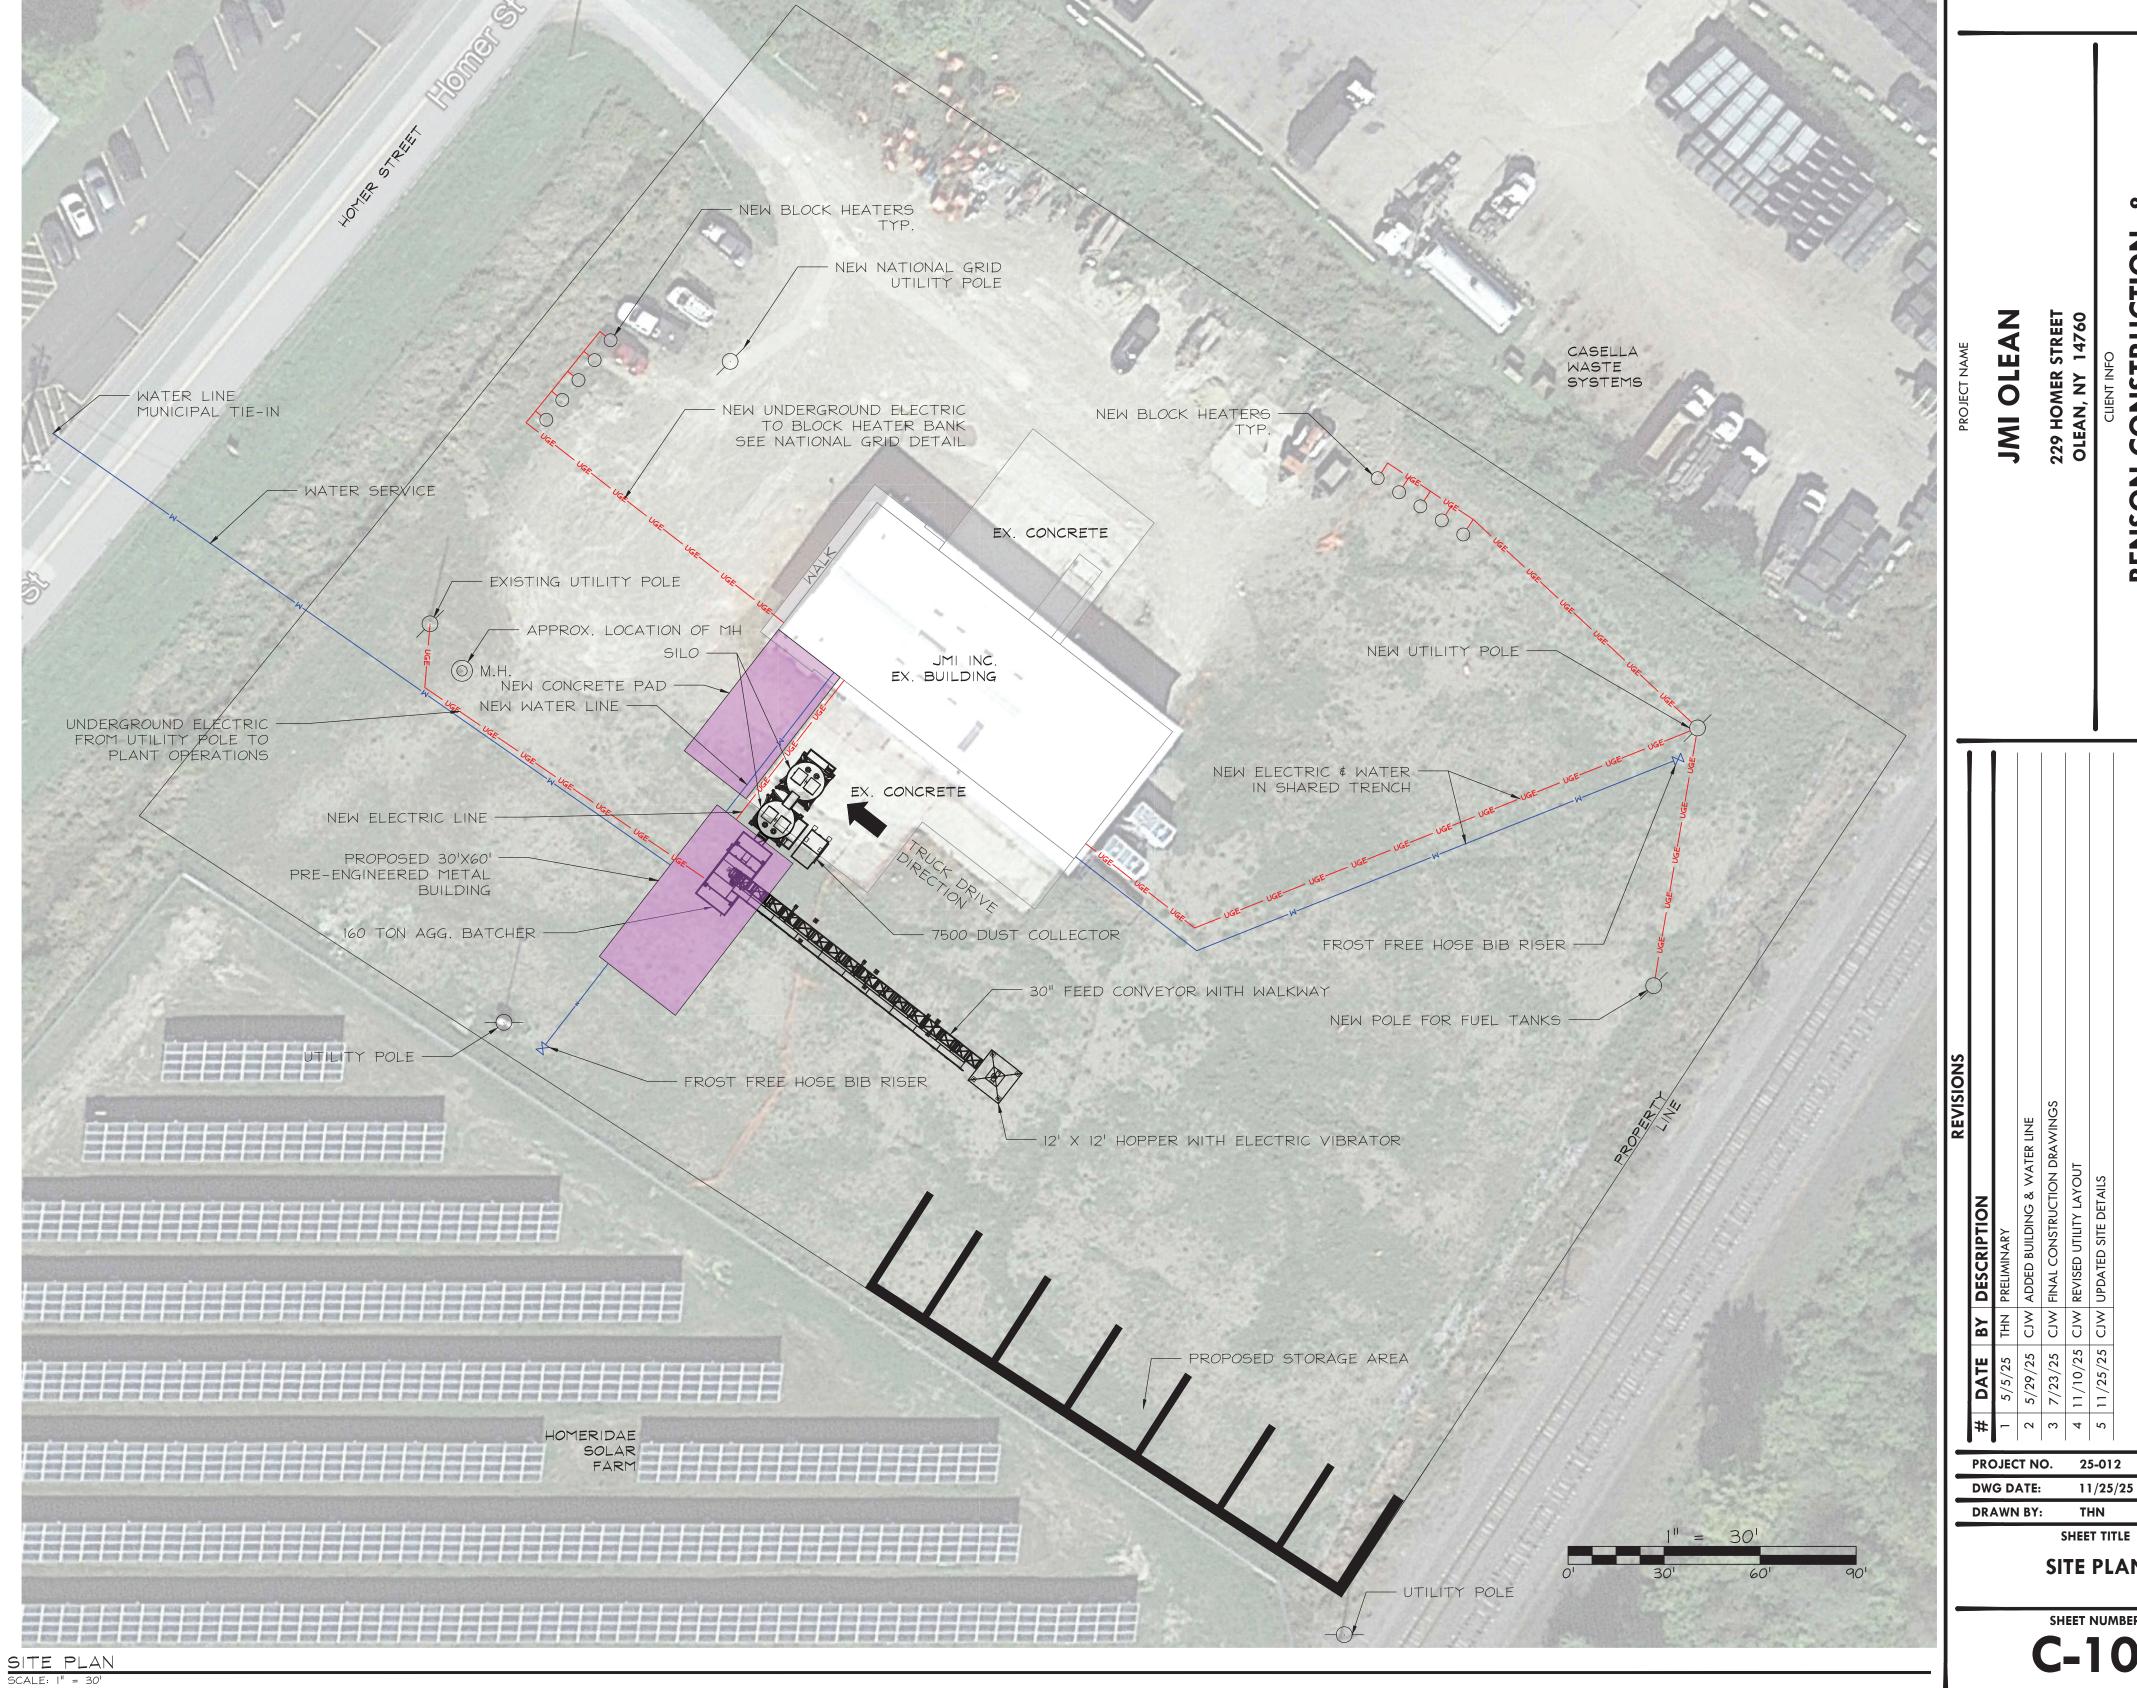




31 BOYLSTON STREET BRADFORD, PA 16701 P: 814.362.2000 cwallace@cjwellc.com

PROFESSIONAL STAMP

	JMI OLEAN		229 HOMER STREET	OLEAN, NY 14760	CLIENT INFO	BENSON CONSTRUCTION &	DEVELOPMENT LLC	130 SOUTH UNION ST OLEAN, NY 14760
# DATE BY DESCRIPTION	1 5/5/25 THN PRELIMINARY	2 5/29/25 CJW ADDED BUILDING & WATER LINE	3 7/23/25 CJW FINAL CONSTRUCTION DRAWINGS	4 11/10/25 CJW REVISED UTILITY LAYOUT	5 11/25/25 CJW UPDATED SITE DETAILS			
PRC	JEC	TN	0.	2	5-01	2		

SHEET TITLE


SITE PLAN

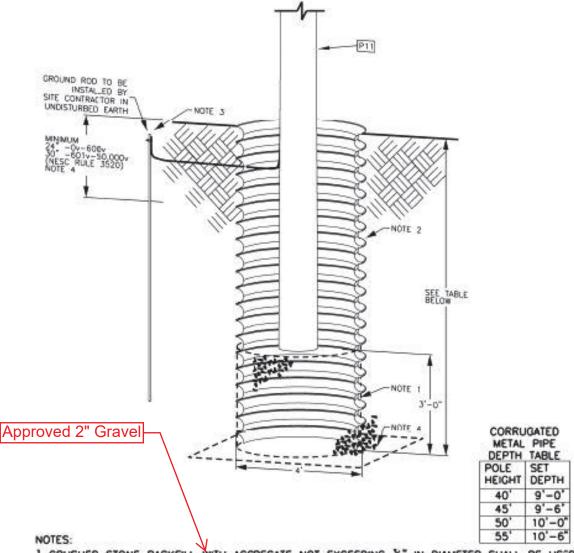

- 1. CRUSHED STONE BACKFILL WITH AGGREGATE NOT EXCEEDING %" IN DIAMETER SHALL BE USED TO BACK FILL POLES, CRUSHED STONE BACKFLL SHALL BE THOROUGHLY TAMPED USING MECHANICAL TAMPERS OR APPROPRIATE HAND TOOLS IN LAYERS NOT EXCEEDING 12" IN DEPTH.

 2. CORRUGATED METAL PIPE WITH CORRUGATIONS 2- 35" X 1/2", MINIMUM 16 GUAGE.
- 3. SEE 13-114 FOR GROUND DETAILS.
- 4. INSTALL GEOTEXTILE FABRIC AS A BARRIER ON ALL CORRUGATED METAL PIPE OPENINGS.
- 5. UTILITY OREWS TO INSTALL POLE AND CONNECT TO GROUNDING ALREADY INSTALLED WITH CORREGATED PIPE, GEOTEXTILE BARRIER AND CRUSHED STONE BACKFILL.
- 6. CORRUGATED STEEL PIPE SHALL BE FREE OF ALL BURS AND JAGGED EDGES IN ORDER TO REDUCE THE RISK OF CUTTING INJURIES DURING HANDUNG. CORRUGATED PIPE SHALL BE FITTED WITH EDGE TRIM SUCH AS NEOPRENE RUBBER TO COVER BURS AND JAGGED EDGES. Designer Onowing Date MPR ed02301 6/30/20

CLEAN CORRIDOR POLE SET						
		PAGE NUMBER	ISSUE			
national grid	OVERHEAD CONSTRUCTION STANDARD	2-301	7/20			

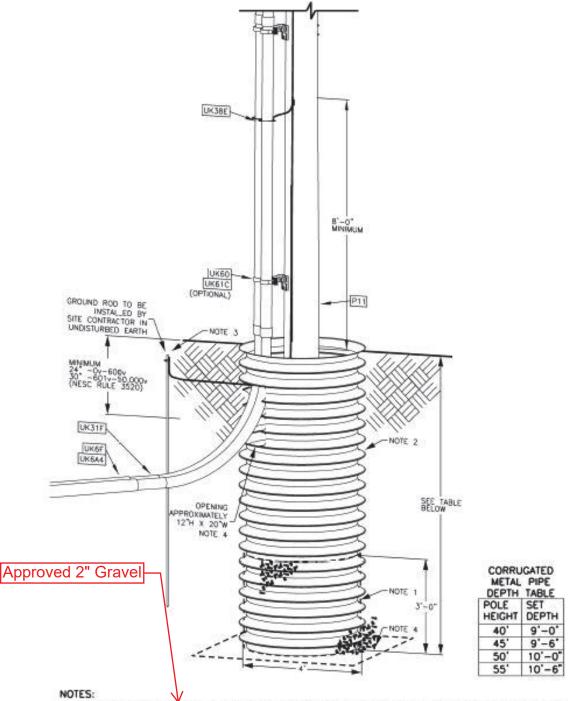

- 1. CRUSHED STONE BACKFILL WITH AGGREGATE NOT EXCEEDING 14" IN DIAMETER SHALL BE USED TO BACK FILL POLES. CRUSHED STONE BACKFILL SHALL BE THOROUGHLY TAMPED USING MECHANICAL TAMPERS OR APPROPRIATE HAND TOOLS IN LAYERS NOT EXCEEDING 12" IN DEPTH.
- 2. CORRUGATED METAL PIPE WITH CORRUGATIONS 2- 35" X 3/4", MINIMUM 16 GUAGE.
- 3. SEE 13-114 FOR GROUND DETAILS.
- 4. INSTALL GEOTEXTILE FABRIC AS A BARRIER.
- 5. CORRUGATED STEEL PIPE SHALL BE FREE OF ALL BURS AND JAGGED EDGES IN ORDER TO REDUCE THE RISK OF CUTTING INJURIES DURING HANDUNG. CORRUGATED PIPE SHALL BE FITTED WITH EDGE TRIM SUCH AS NEOPRENE RUBBER TO COVER BURS AND JAGGED EDGES.

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